TENANT IMPROVEMENT FOR:


14400 S FIGUEROA STREET, GARDENA, CA 90248


REXFORD INDUSTRIAL REALTY

11620 Wilshire Boulevard, Suite 610 Los Angeles, CA 90024

ABB	REVIATIONS			OWNER INFORMATION
				REXFORD INDUSTRIAL REALTY
@ A.B.	AT ANCHOR BOLT	JAN. JST.	JANITOR JOIST	11620 Wilshire Blvd Suite 610
A.C. ACOUS.	ASPHALTIC CONCRETE ACOUSTICAL	JT.	JOINT	Los Angeles, CA 90024
ALT.	ALTERNATE	K.C.	KEENE'S CEMENT	(424) 440-2565
ACS. A.D.	ACRES AREA DRAIN	KIT.	KITCHEN	
ALUM. A.T.	ALUMINUM ASPHALT TILE	LAM.	LAMINATED	NAME: Brian Garcia bgarcia@rexfordindustrial.com
ADJ. A.F.F.	ADJUSTABLE ABOVE FINISH FLOOR	LAV. LGTH LKR.	LAVATORY LENGTH LOCKER	CONSULTANT INFORMATION
A.F.S. B.C./B.O.C.	ABOVE FINISH SURFACE BOTTOM OF CONCRETE	L.P.	LOW POINT	ARCHITECT for Shell Building
BD.	BOARD	MIN. MAS.	MINIMUM MASONRY	
BLK. BLKG.	BLOCK BLOCKING	MAX.	MAXIMUM	BSB DESIGN, INC.
B.M.	BOTTOM OF MULLION	MECH. MEMB.	MECHANICAL MEMBRANE	970 W. 190TH STREET SUITE 250
BM. BOT.	BEAM BOTTOM	MET.	METAL MANHOLE	TORRANCE, CA 90502
BLDG. BET.	BUILDING BETWEEN	M.H. MISC.	MISCELLANEOUS	OFFICE: (310) 217-8885 DIRECT (424) 266-6942
DL1.	DETWEEN	M.O. M.R.	MASONRY OPENING MOISTURE RESISTANT	
C.L. C.B.	CENTER LINE CATCH BASIN	MFG.	MANUFACTURER	Alan Makalinao amakalinao@bsbdesign.com
CEM. CER.	CEMENT CERAMIC	N.I.C.	NOT IN CONTRACT	LANDSCAPE ENGINEER
C.I.P. CLG.	CAST IRON PIPE CEILING	NO. NOM.	NUMBER NOMINAL	CUMMINGS CURLEY AND ASSOCIATES
CLO.	CLOSET	N.T.S.	NOT TO SCALE	1700 Pacific Coast Highway Suite C
CLR. C.O.	CLEAR CLEAN OUT	OBSC.	OBSCURE	
COL.	COLUMN	O.C. O.D.	ON CENTER	Seal Beach, CA 90740
COM. CONC.	COMMON CONCRETE	O.D. OFF.	OUTSIDE DIAMETER OFFICE	Office (562) 424-8181
CONT.	CONTINUOUS	OPG. OV.	OPENING OVEN	
C.W. C.T.	COLD WATER CERAMIC TILE	OVFL.	OVERFLOW	Contact: Robert L. Curley
C.YD.	CUBIC YARD	OPP.	OPPOSITE	CIVIL ENGINEER
DET.	DETAIL	PL. PART'N	PROPERTY LINE/PLATE PARTITION	CANNON
D.F. D.D.	DRINKING FOUNTAIN DOOR DIMENSION	PLAS.	PLASTER	16842 Von Karman Ave
DIA.	DIAMETER	PLYWD. PR.	PLYWOOD PAIR	
DRWG. D.S.	DRAWING DOWNSPOUT	P.L.	PLASTIC LAMINATE	Irvine, CA 92606
D.W. DR.	DISHWASHER DOOR	R.	RISER	Office (949) 681-0255
DIM.	DIMENSION	RAD.	RADIUS	
(E)	EXISTING	REINF. RESIL.	REINFORCING RESILIENT	Contact: Sammuel J. Jacoby
EA.	EACH	RD.	ROOF DRAIN	
ELEC. ELEV.	ELECTRICAL ELEVATION	RM. R.O.	ROOM ROUGH OPENING	BUILDING DEPARTMENT
ENCL.	ENCLOSURE	REF. REV.	REFRIGERATOR REVERSE	
EXH. EXIST.	EXHAUST EXISTING	REQ'D.	REQUIRED	LOS ANGELES COUNTY
EXP. EXT.	EXPANSION EXTERIOR	S.C.	SOLID CORE	
E.J.	EXPANSION JOINT	SHT.	SHEET	COUNTY OF LOS ANGELES
E.S.	EDGE OF SLAB	SIM. SHTG.	SIMILAR SHEATHING	320 W TEMPLE ST. STE 13
F.D.	FLOOR DRAIN	SQ.	SQUARE	LOS ANGELES, CA 90012
F.E.C. F.G.	FIRE EXTINGUISHER CAB. FUEL GAS	STD. STL.	STANDARD STEEL	
F.H.C.	FIRE HOSE CABINET	STRUCT. S.S.	STRUCTURAL STAINLESS STEEL	Office (213) 974-6411
FIN. FLR.	FINISH FLOOR	SUSP.	SUSPENDED	
FLRG.	FLOORING	SPECS. STOR.	SPECIFICATIONS STORAGE	
FTG. F. GL.	FOOTING FIXED GLASS	S.T.C.	SOUND TRANSMISSION CLASS	
F.S. FLUOR.	FLOOR SINK FLUORESCENT	S.F.	SQUARE FOOT	
F.O.C.	FACE OF CONCRETE			
F.O.M. F.O.S.	FACE OF MASONRY FACE OF STUD	T.C./T.O.C. TEL.	TOP OF CONCRETE TELEPHONE	
F.O.F.	FACE OF FINISH	TERR.	TERRAZZO	
F.O.SH. F.F.	FACE OF SHEATHING FINISH FLOOR	T & G T.M.	TONGUE AND GROOVE TOP OF MULLION	
F.J.	FLOOR JOIST	T.O.W. TYP.	TOP OF WALL TYPICAL	
GA.	GAUGE	THRU	THROUGH	
GALV. G.I.	GALVANIZED GALVANIZED IRON	TEMP. T.O.P./T.P.	TEMPERED TOP OF PARAPET	
GL. GR.	GLASS GRADE	T. T.O.PL.	TREAD TOP OF PLATE	
GK. GYP. BD. G.D.	GYPSUM BOARD GARBAGE DISPOSAL	T.S.	TOP OF SHEATHING	
		U.	URINAL	
H.B. H.C.	HOSE BIBB HOLLOW CORE	U.N.O.	UNLESS NOTED OTHERWISE	

	14400 S FIGUEROA ST., GAR 400 W ROSECRANS AVE., G. 422 W ROSECRANS AVE., G.	ARDENA, CA 90248		
ZONING:	422 W NOSECIVANS AVE., G	ANDENA, CA 90240		
	M2-1VL-O (LIGHT MANUFAC	TURING)		_
	M-2-IP (HEAVY MANUFACTU	RING, INDUSTRIAL PRESE	ERVATION)	
ASSESSO	R PARCEL NO. (A.P.N.):		
	6129-001-029 CITY OF LOS A	NGELES JURISDICTION		
	6129-001-028 COUNTY OF LO	OS ANGELES JURISDICTIO	NC	
	6129-001-023 COUNTY OF LO	OS ANGELES JURISDICTIO	ON	
	6129-001-024 COUNTY OF LO	OS ANGELES JURISDICTIO	ON	
AREA OF	WORK: TOTAL LOT AREA: 271,847	SQ. FT.		
	TOTAL LOT AREA: 271,847	JLATIONS	PER TABLE 1	-
	TOTAL LOT AREA: 271,847		PER TABLE 1 # OF OCCUF	-
	TOTAL LOT AREA: 271,847	JLATIONS		-
	TOTAL LOT AREA: 271,847 NCY LOAD CALCU USE (OCCUPANCY) OFFICE (B):	JLATIONS AREA	# OF OCCUF	PA
	TOTAL LOT AREA: 271,847 NCY LOAD CALCU USE (OCCUPANCY) OFFICE (B): FIRST FLOOR WAREHOUSE (S-1):	JLATIONS AREA 3,939 SF / 150 =	# OF OCCUF	-
	TOTAL LOT AREA: 271,847 NCY LOAD CALCU USE (OCCUPANCY) OFFICE (B): FIRST FLOOR WAREHOUSE (S-1): WITH OFFICE PROPOSED TOTAL	JLATIONS AREA 3,939 SF / 150 = 52,059 SF / 500 =	# OF OCCUF	PA

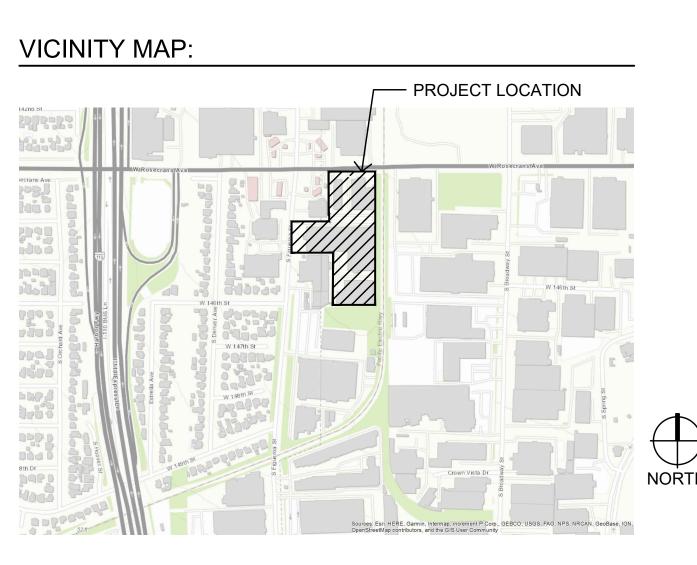

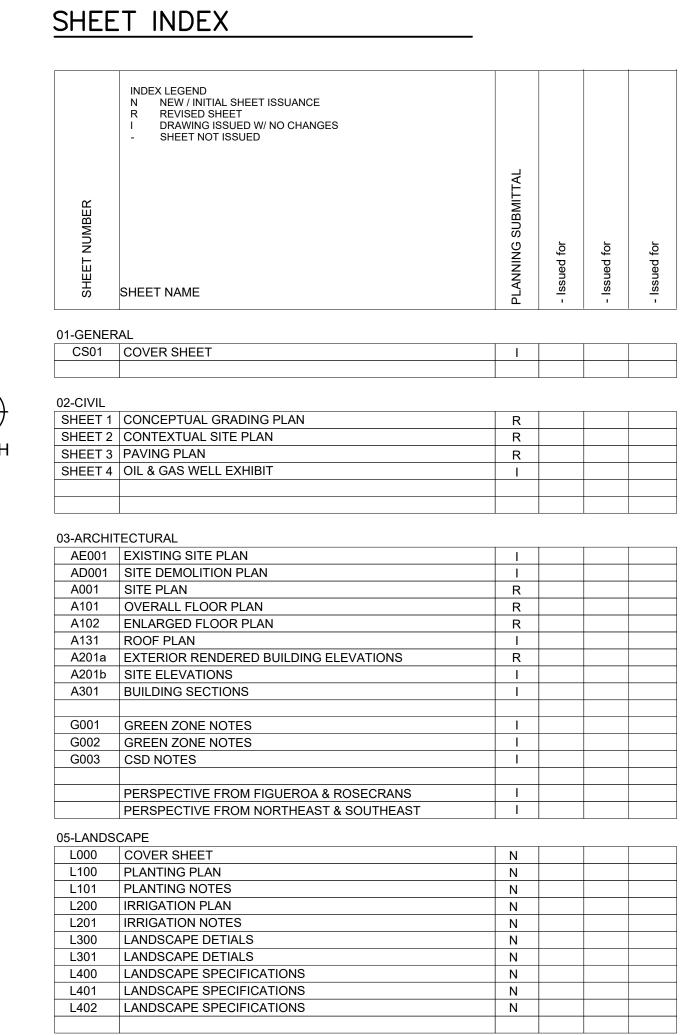



CM220364 JOB NO. **SUBMITTAL** CITY SUBMITTAL 10/25/23 03/22/24 04/17/24 BID ADDENDUM 'A' PLANNING RESUBMITTAL 1 06/20/24


REVISION LADBS & LA COUNTY CORR. 02.06.24 04/15/24 BID ADDENDUM 'A' 04/23/24 BID ADDENDUM 'B' 06/21/24 BID ADDENDUM 'C'

LADBS STAMP





NDO

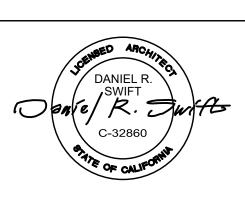



BSBDESIGN.COM

COVER SHEET

CS01

JUNE 20, 2024 PLANNING RESUBMITTAL 1

03/22/2024

WALL TYPE SECTION DESIGNATION SHEET NUMBER ### KEY NOTE SHEET NUMBER # MATERIAL FINISH

VESTIBULE

WATERPROOF

---ROOM NAME ### ----ROOM NUMBER

WINDOW NUMBER/TYPE

VINYL COMPOSITION TILE

HOLLOW CORE HARDWOOD HEIGHT

HIGH POINT

HOT WATER HORIZONTAL

INSIDE DIAMETER

IMPACT INSULATION CLASS

INSULATION INVERT IRON PIPE SIZE

SHT. NO.

EXTERIOR ELEV.


DET. NO.

INTERIOR ELEV.


DET. NO.

SYMBOLS


HEADER

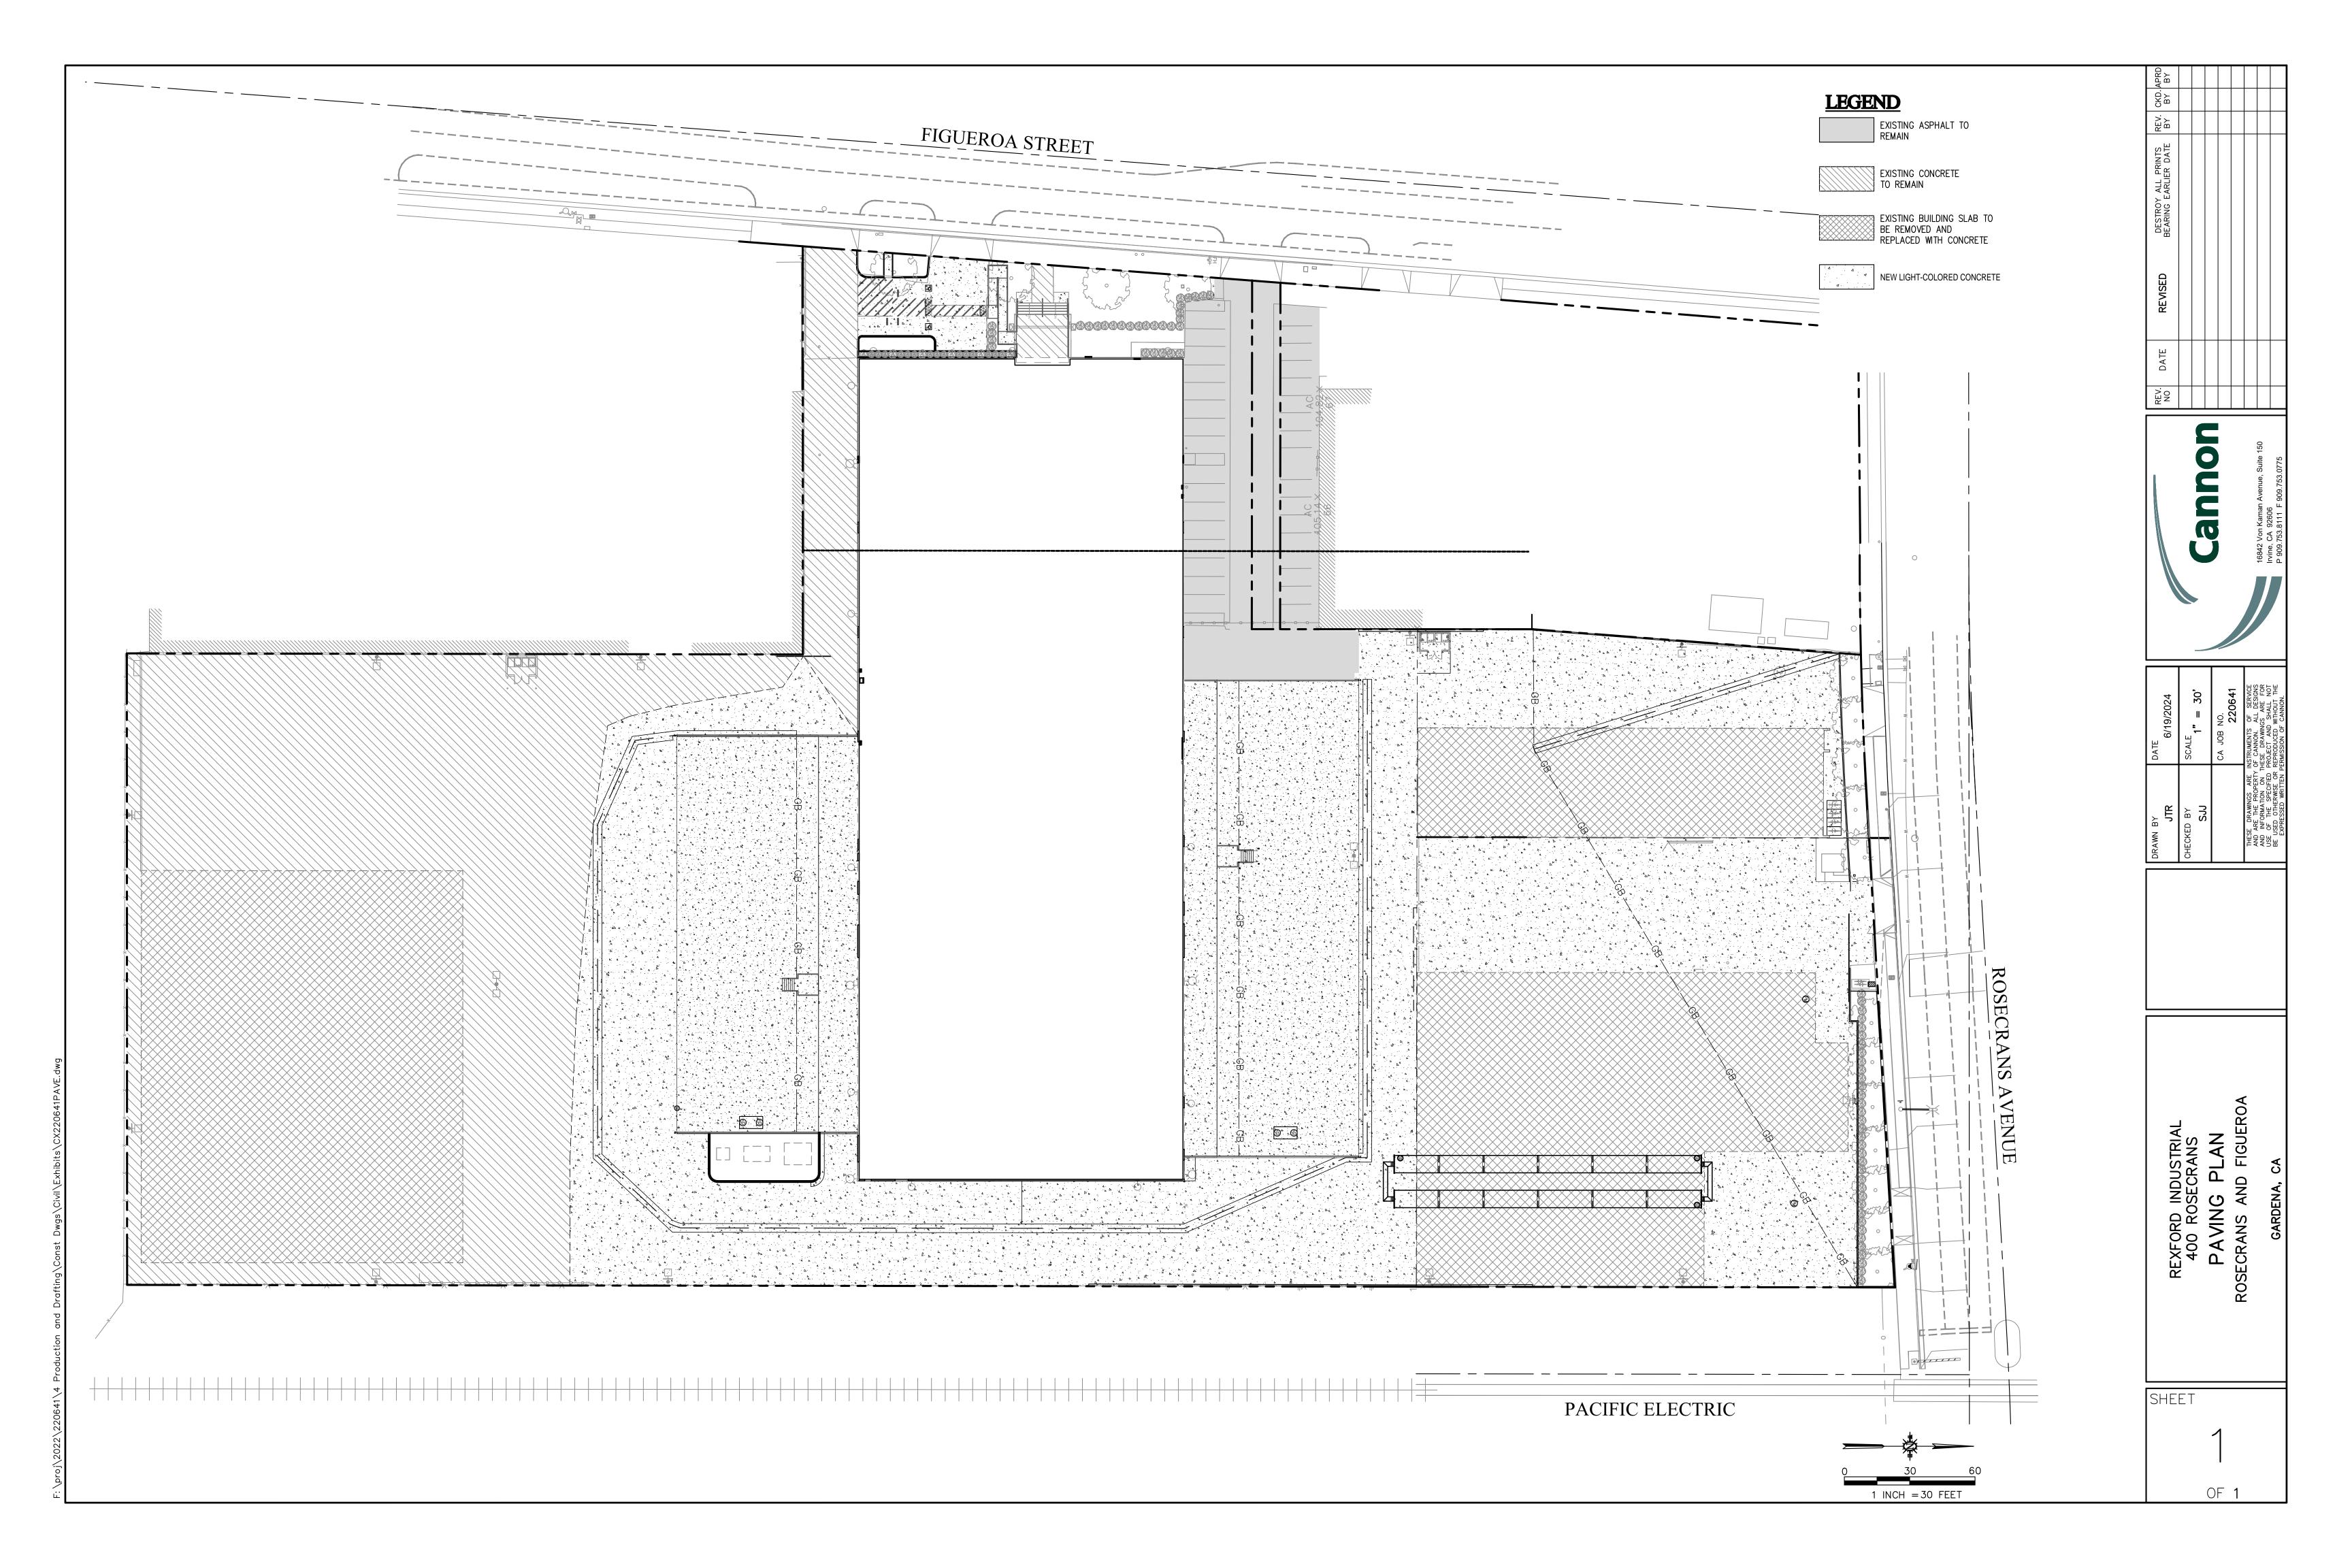



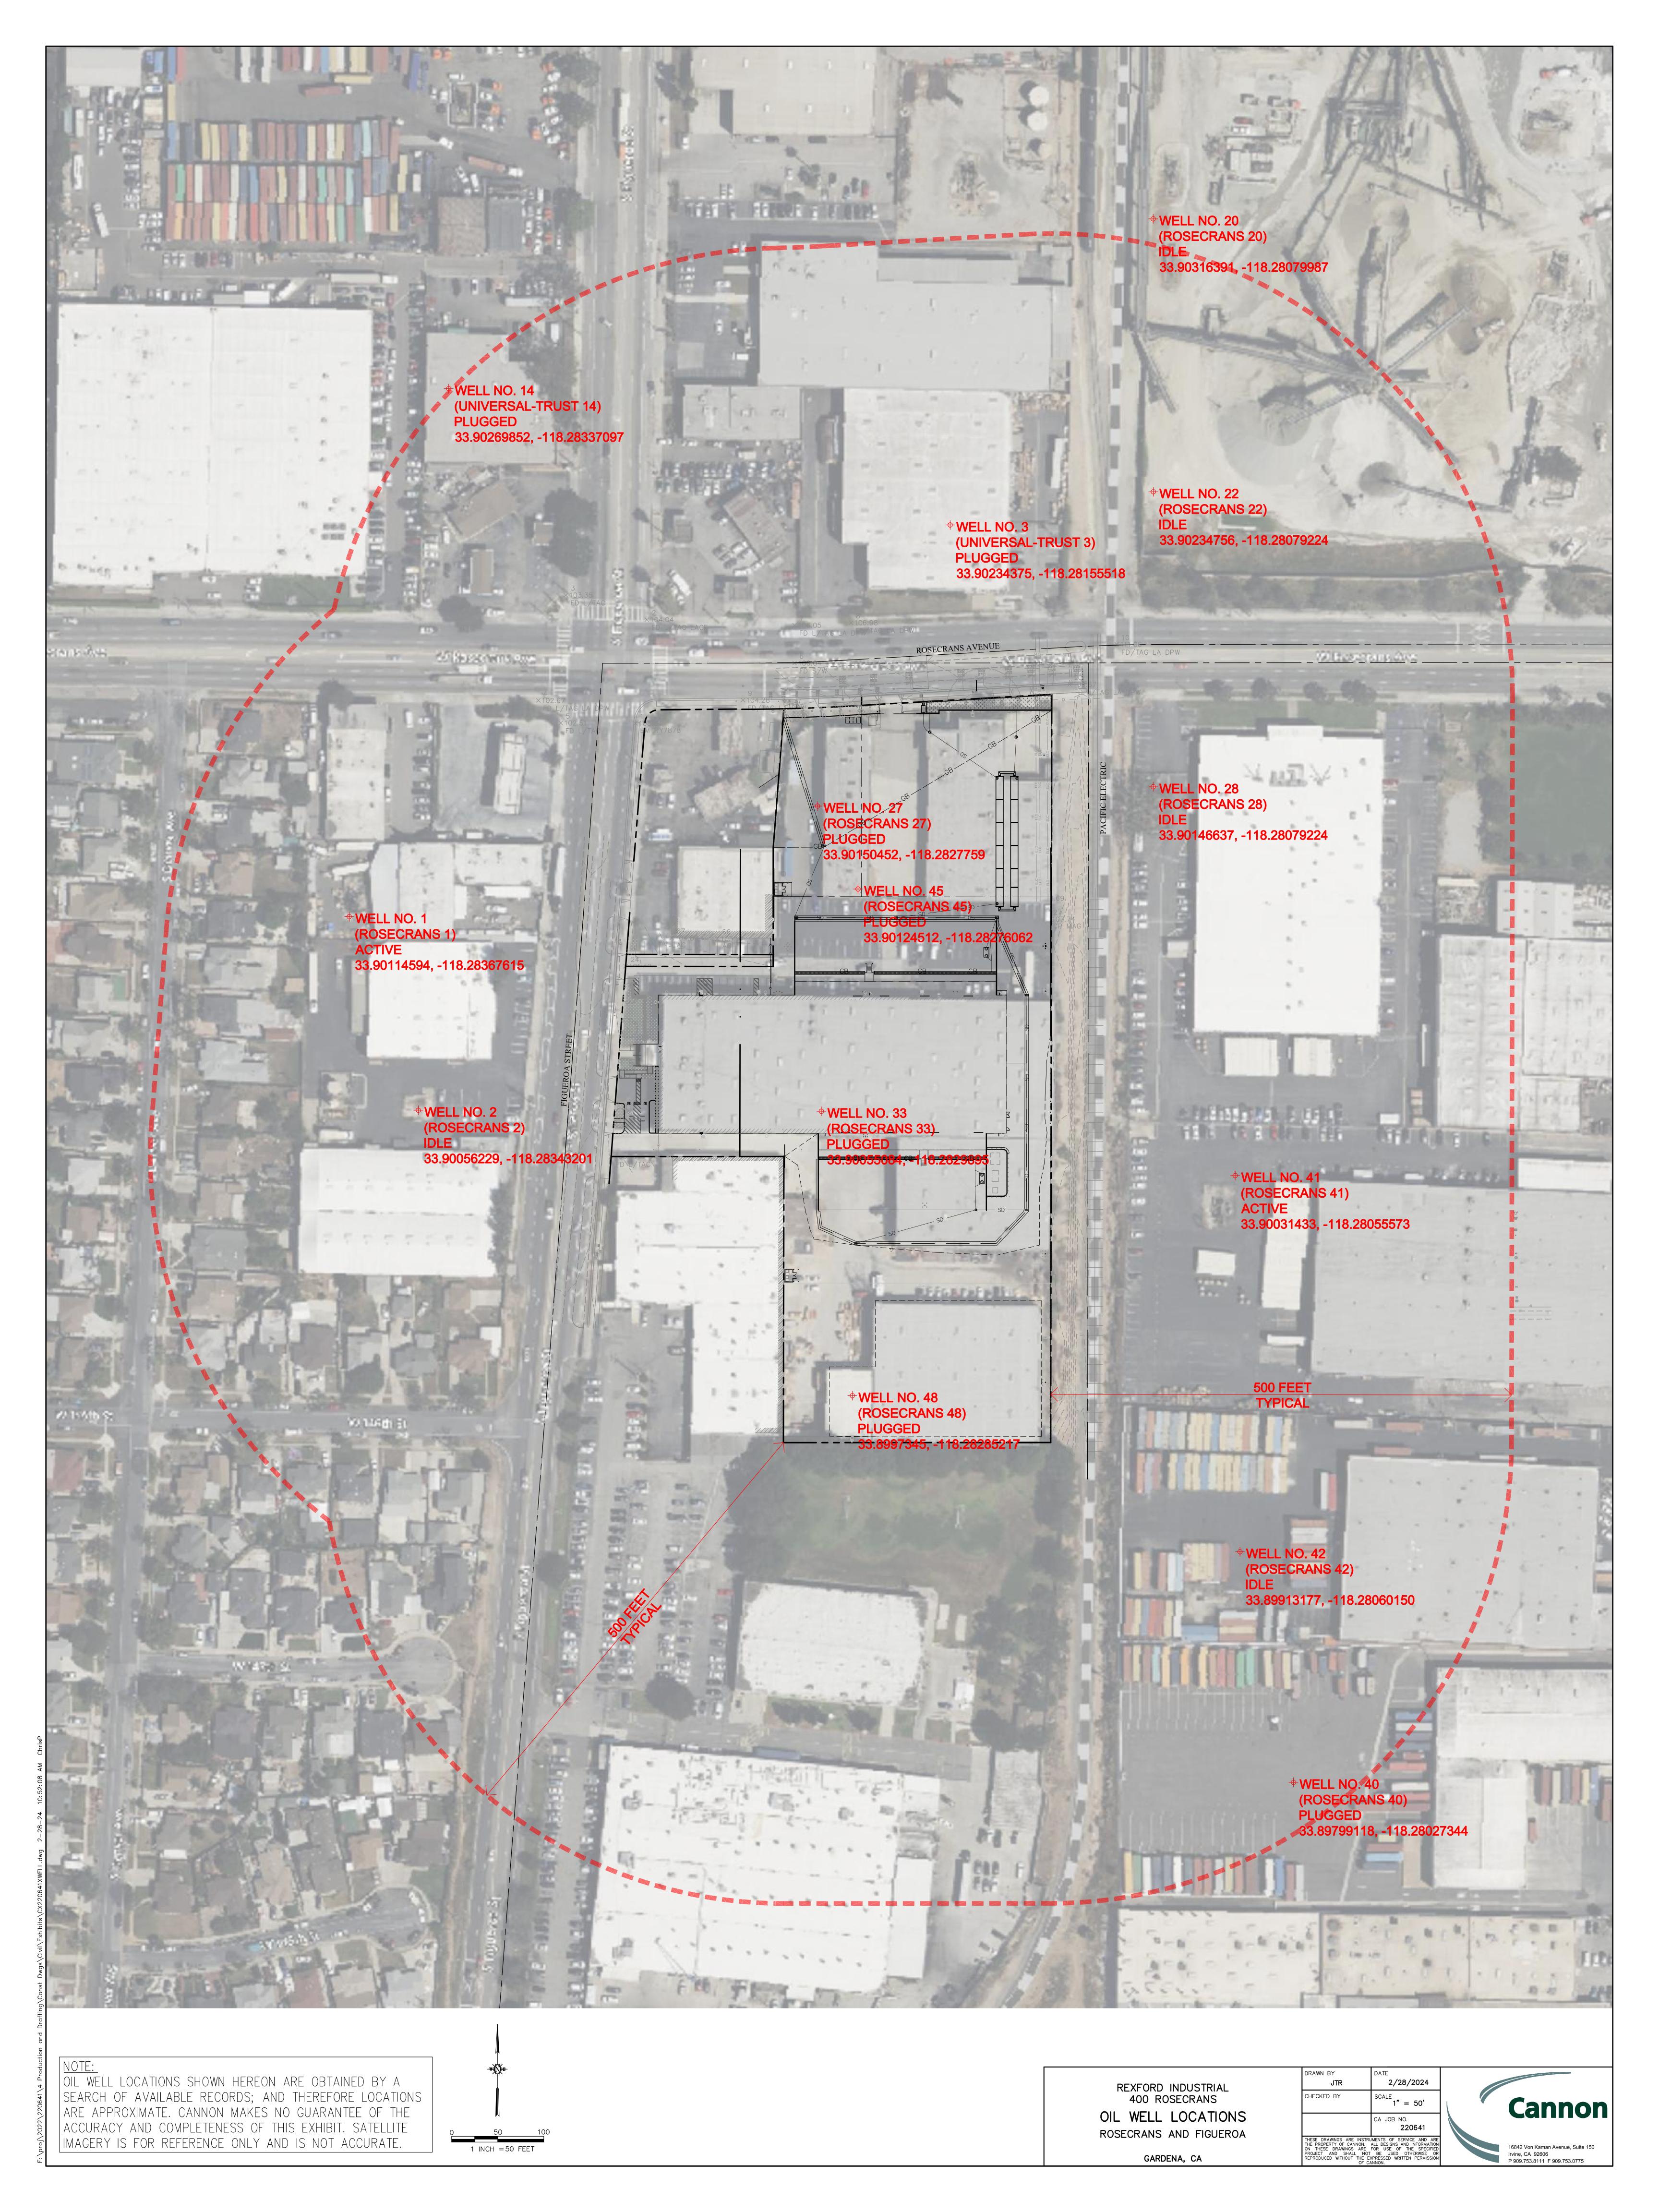

KEYNOTES		LEGEND
1 EXISTING LIGHT POLE	10 EXISTING CONCRETE SHEAR WALL	# INDICATES NUMBER OF PARKING STALLS
2 EXISTING DRIVEWAY	11) EXISTING GATE	
3 EXISTING DRIVEWAY TO BE CLOSED OFF	12 EXISTING DRIVEWAY TO EXPAND	——— EXISTING PROPERTY LINE
4 EXISTING FENCE	13 EXISTING FIRE HYDRANT	INDICATES EXISTING ACCESS EASEMENT
5 EXISTING POWER POLE	(14) EXISTING TREES	
6 PARKING STALLS	15 EXISTING SHORT WALL	
7 EXISTING LANDSCAPE	16 EXISTING SECURITY BOLLARD	
8 20' WIDE EXISTING ACCESS EASEMENT (TBD) WITH AN AREA OF APPROX. 4,160 SF.	17> EXISTING SIGNAGE	
9 EXISTING PATHWAY	(18) EXISTING SHED	

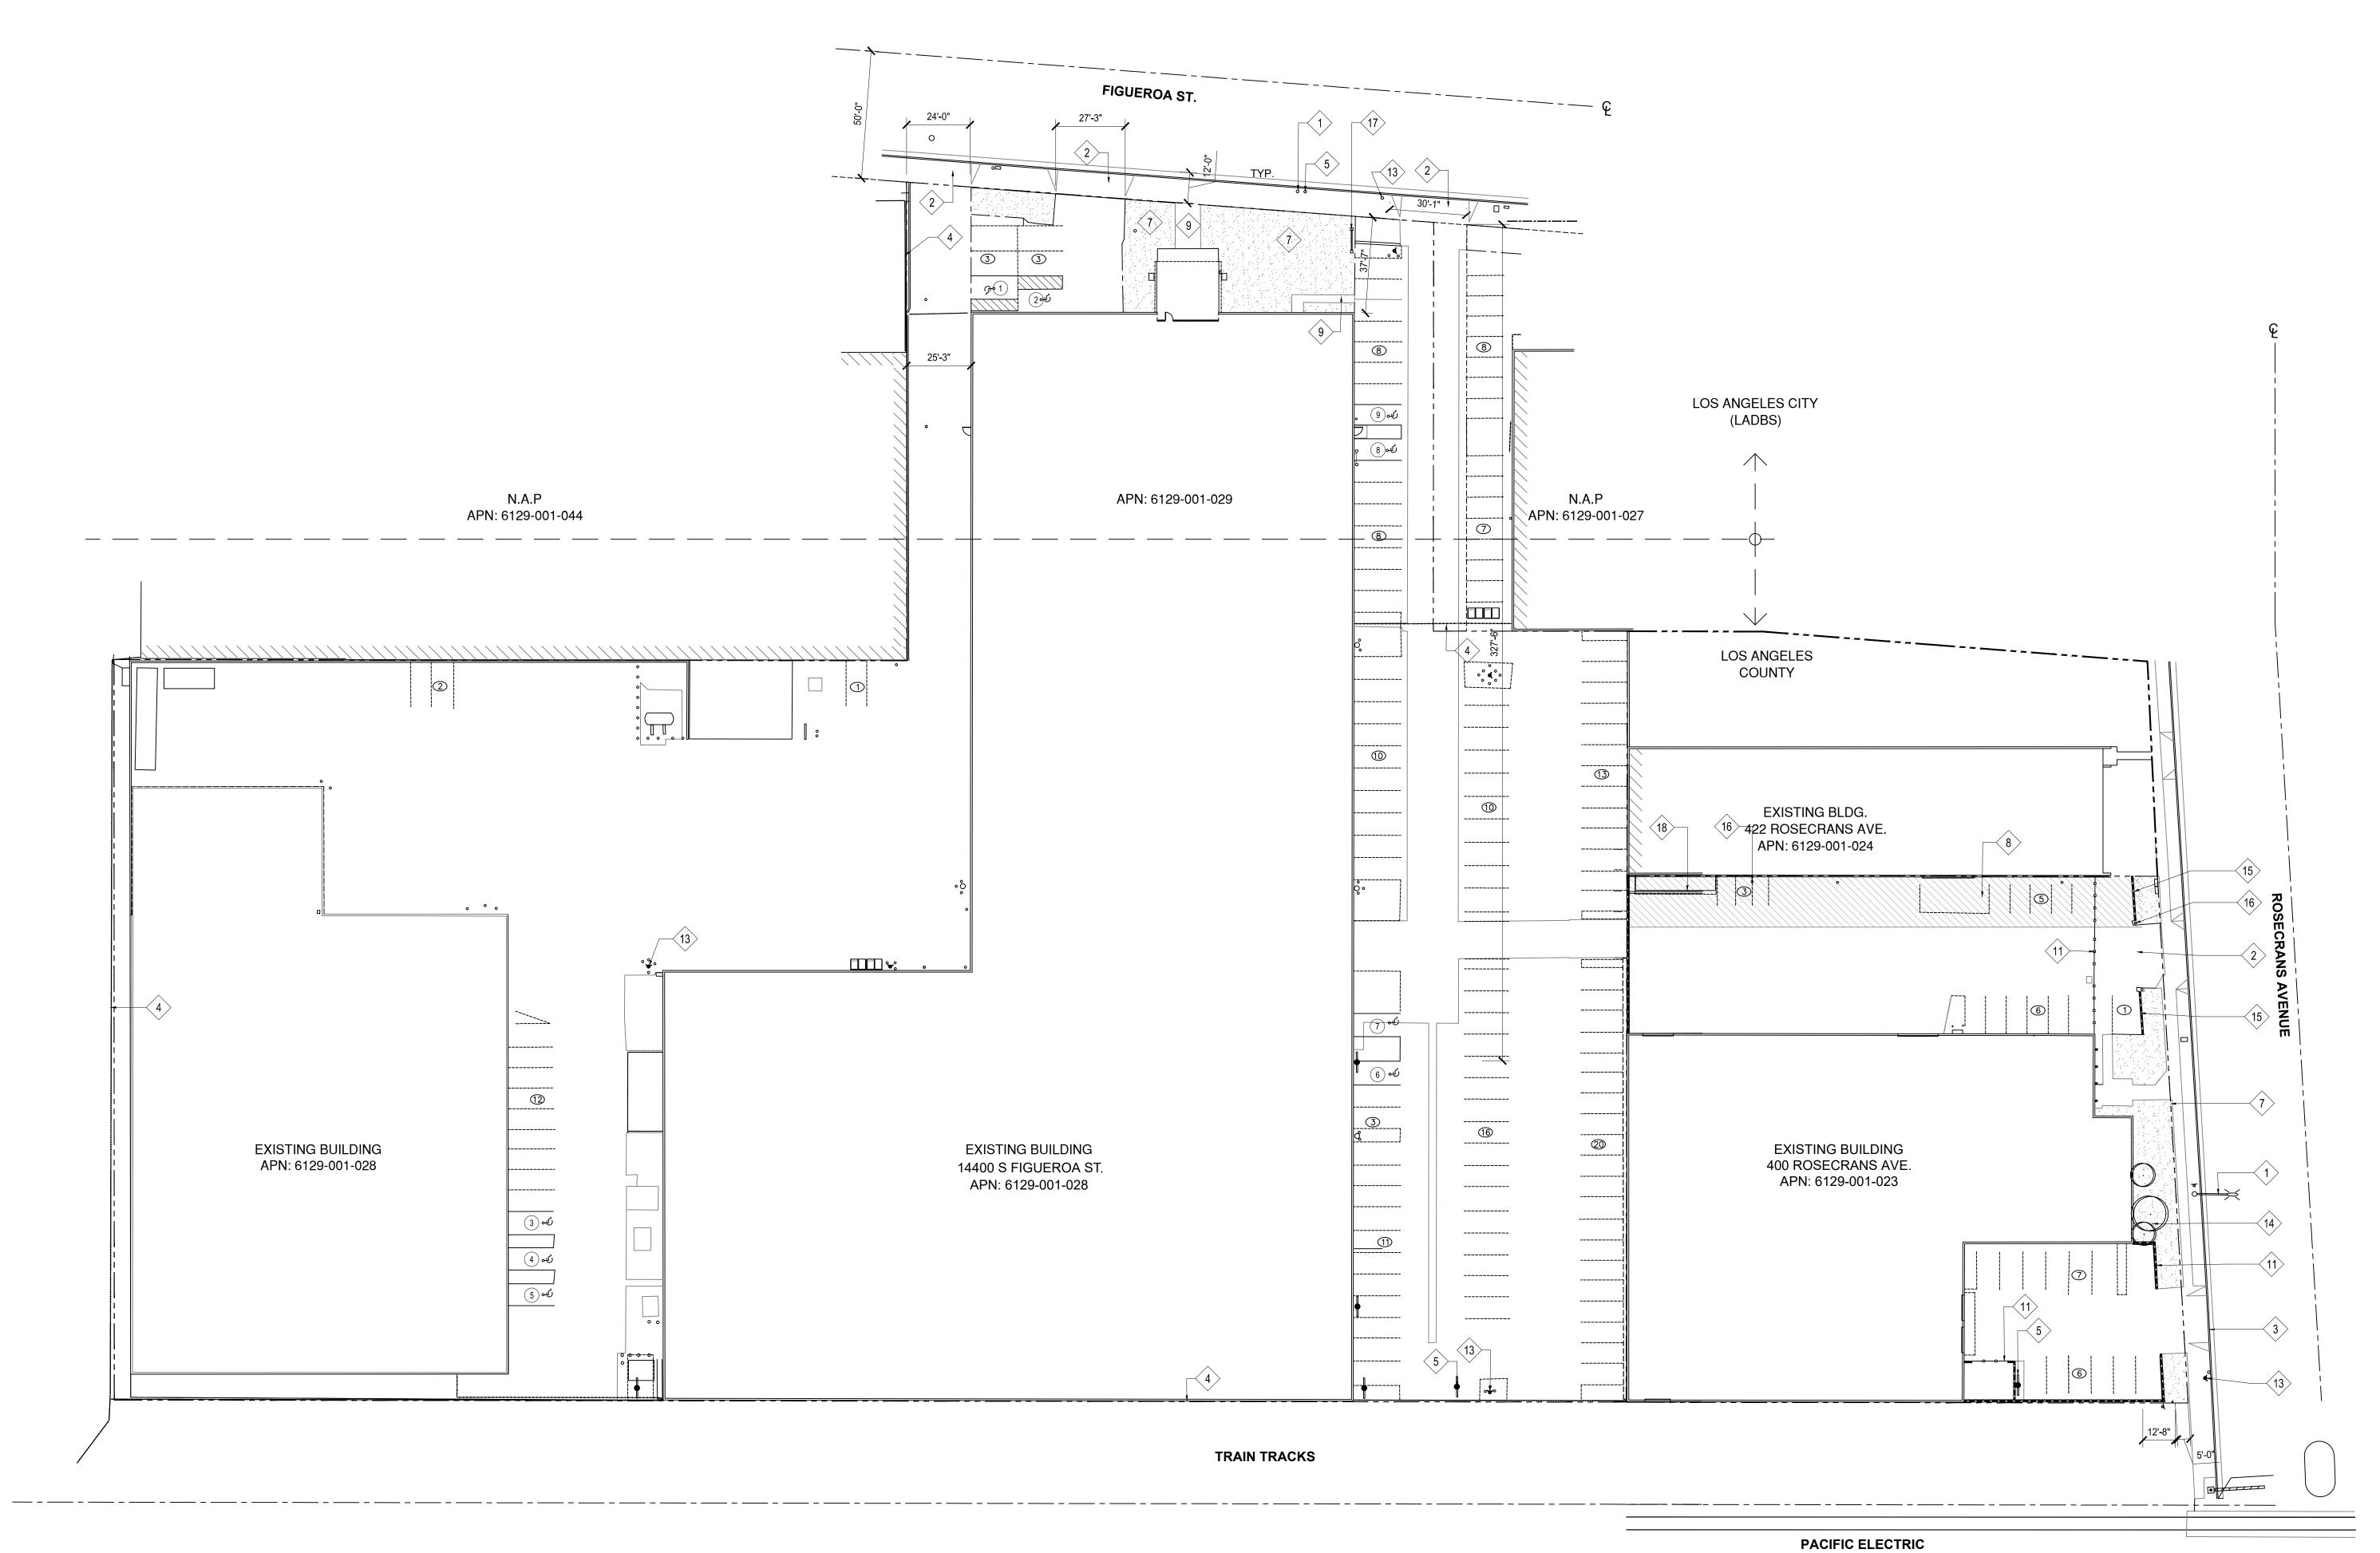

EXISTING CONDITIONS PLAN
1" = 30'-0"

		suela pui
	NORTH	designs and
	걸	0 0 0 0

SHEET NO. AE001 February 06, 2024 SUBMITTAL SET

REVISION	DA
<u>-</u>	
LADBS STAMP	
CLIENT:	

CM220364

DATE

10/25/23


JOB NO.

SUBMITTAL

CITY SUBMITTAL


INDUS.

11620 WILSHIRE BOULEV LOS ANGELES, CA 90024

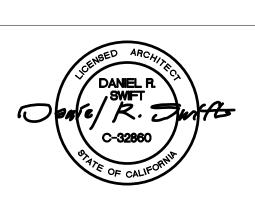



SHEET TITLE **EXISTING CONDITION PLAN**

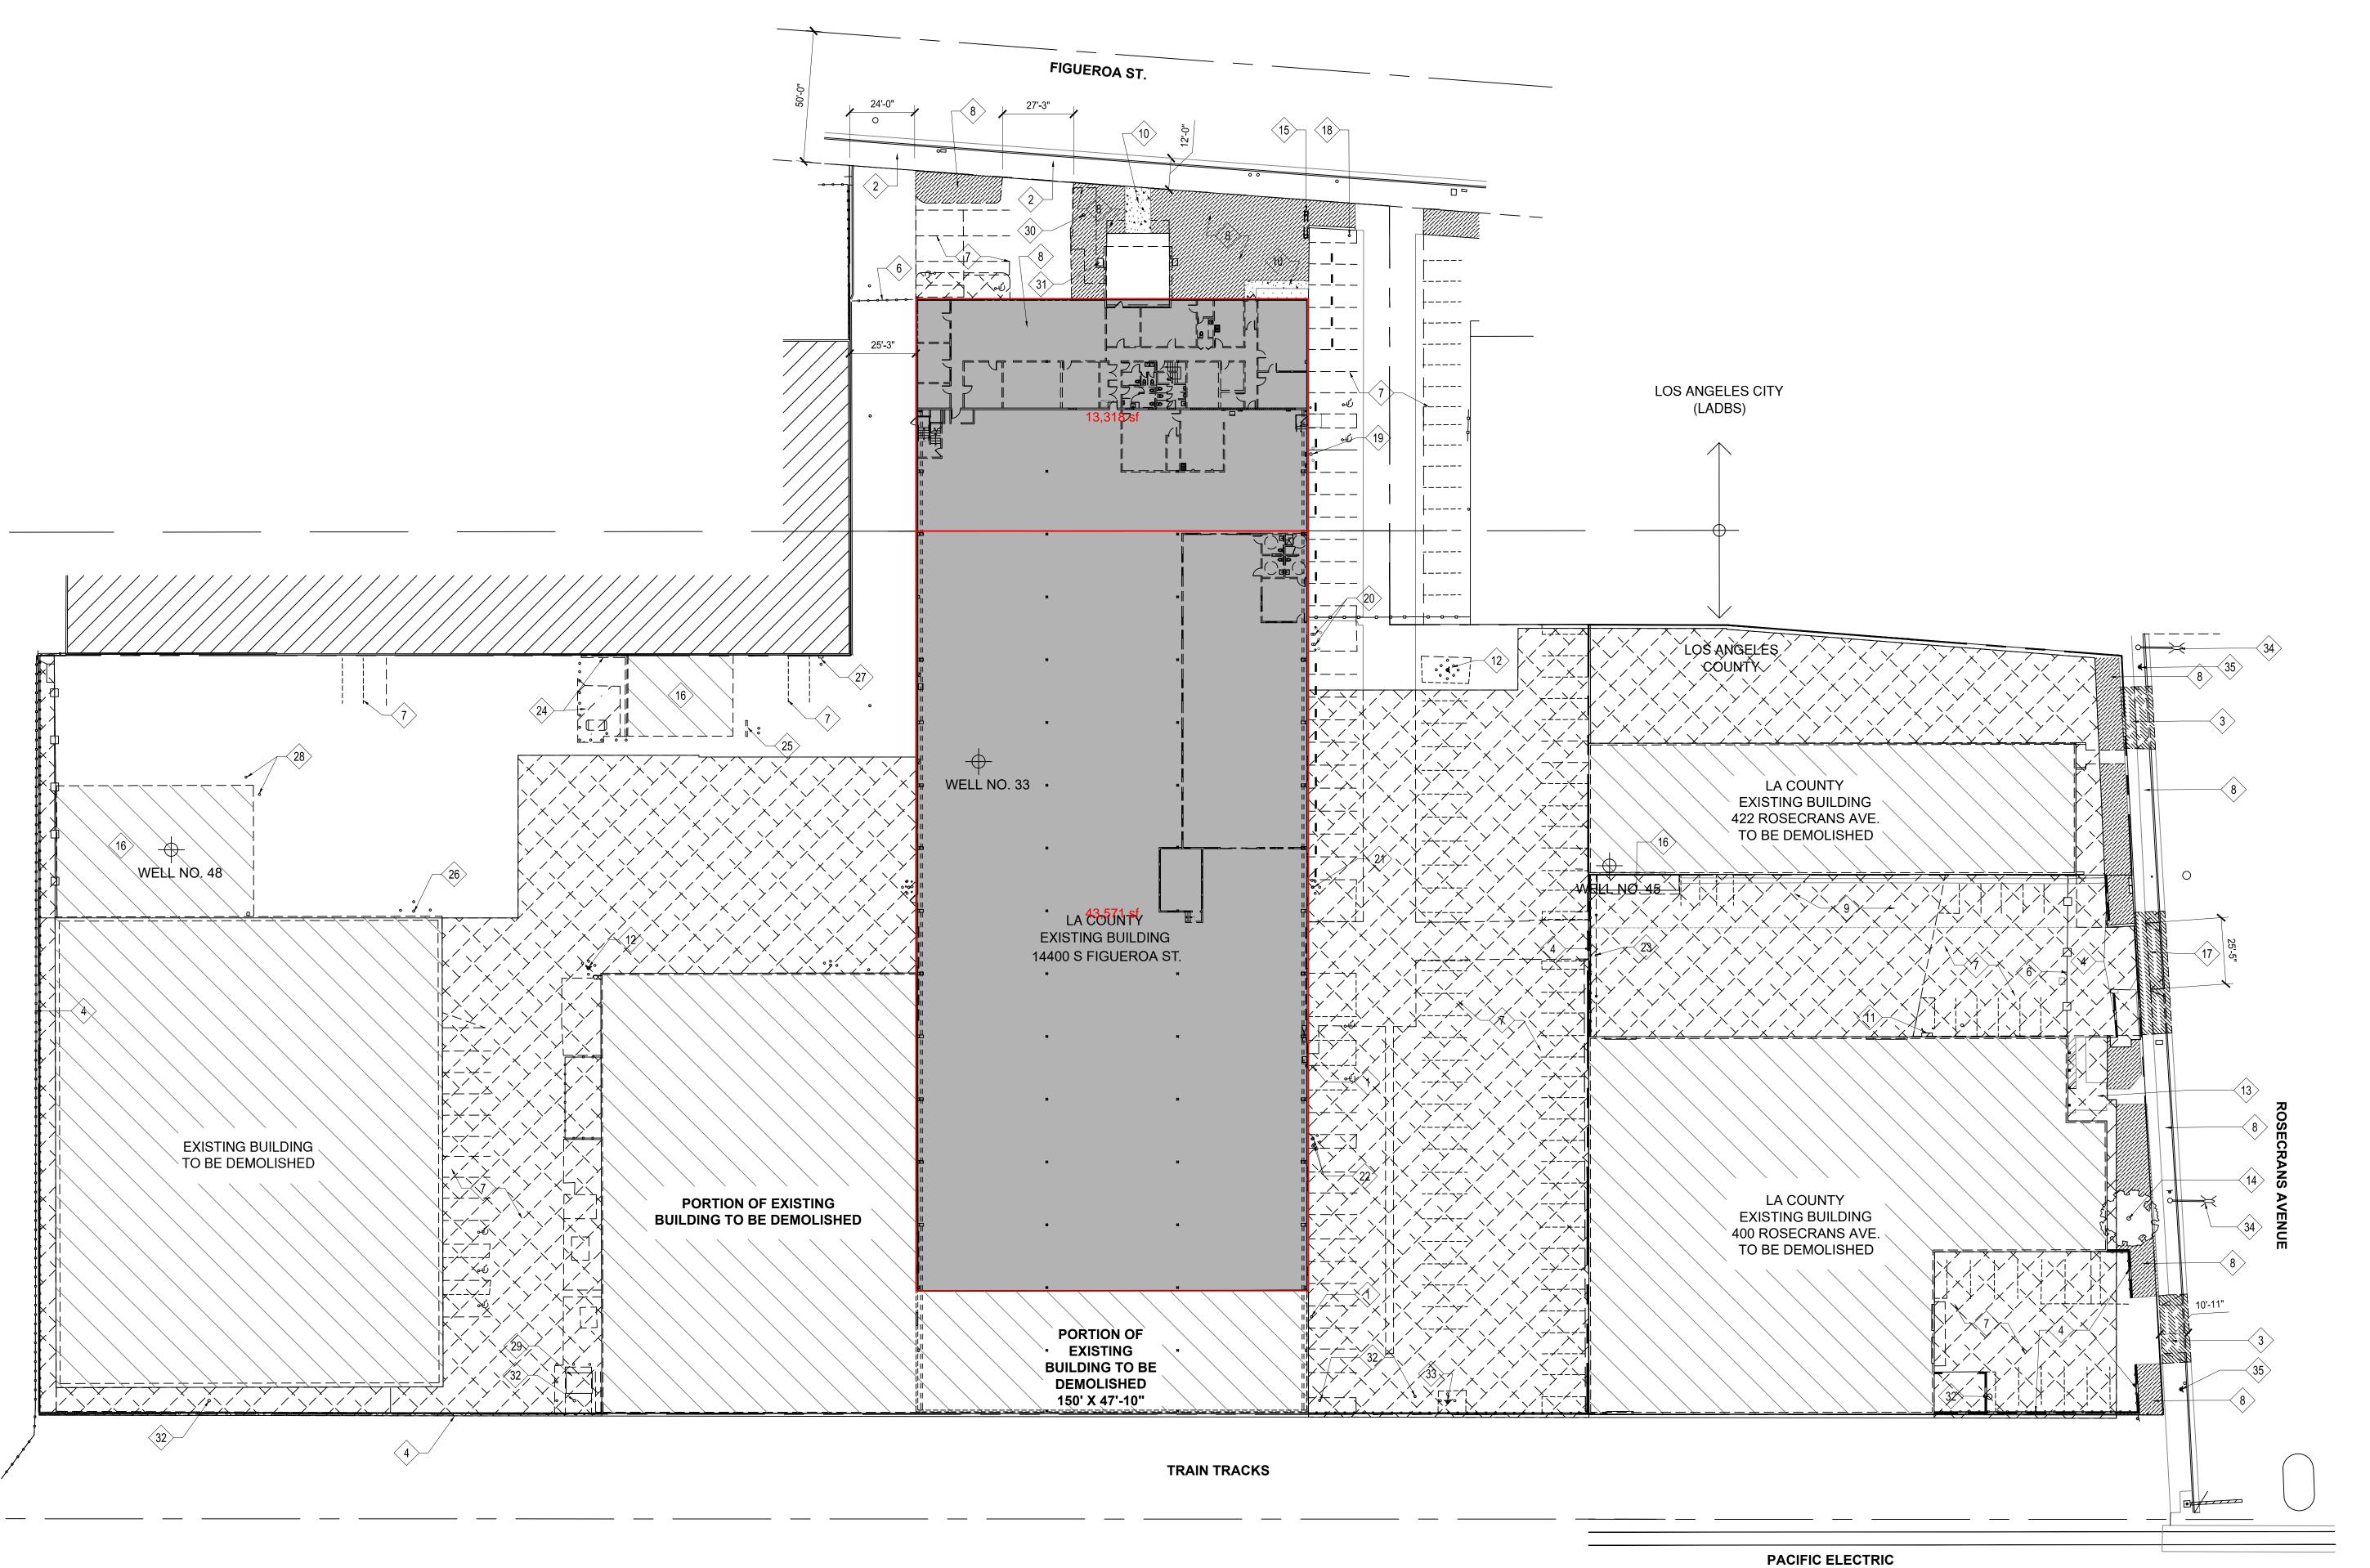

NORTH

JOB NO. CM220364

SUBMITTAL DATE
CITY SUBMITTAL 10/25/23

REVISION DATE
LADBS & COUNTY PC CORR. 02.06.24

LADBS STAMP

Rexford Industrial

30240 NDUSTRIAL REALTY

GARDENA, CA 902 CLENT: REXFORD IND

DANIEL R.
SWIFT

C-32860

OTATE OF CALIFORNIA




SHEET TITLE

DEMO SITE PLAN

DEMO SITE PLA

SHEET NO. AD001

February 06, 2024 SUBMITTAL SET 02/06/2024

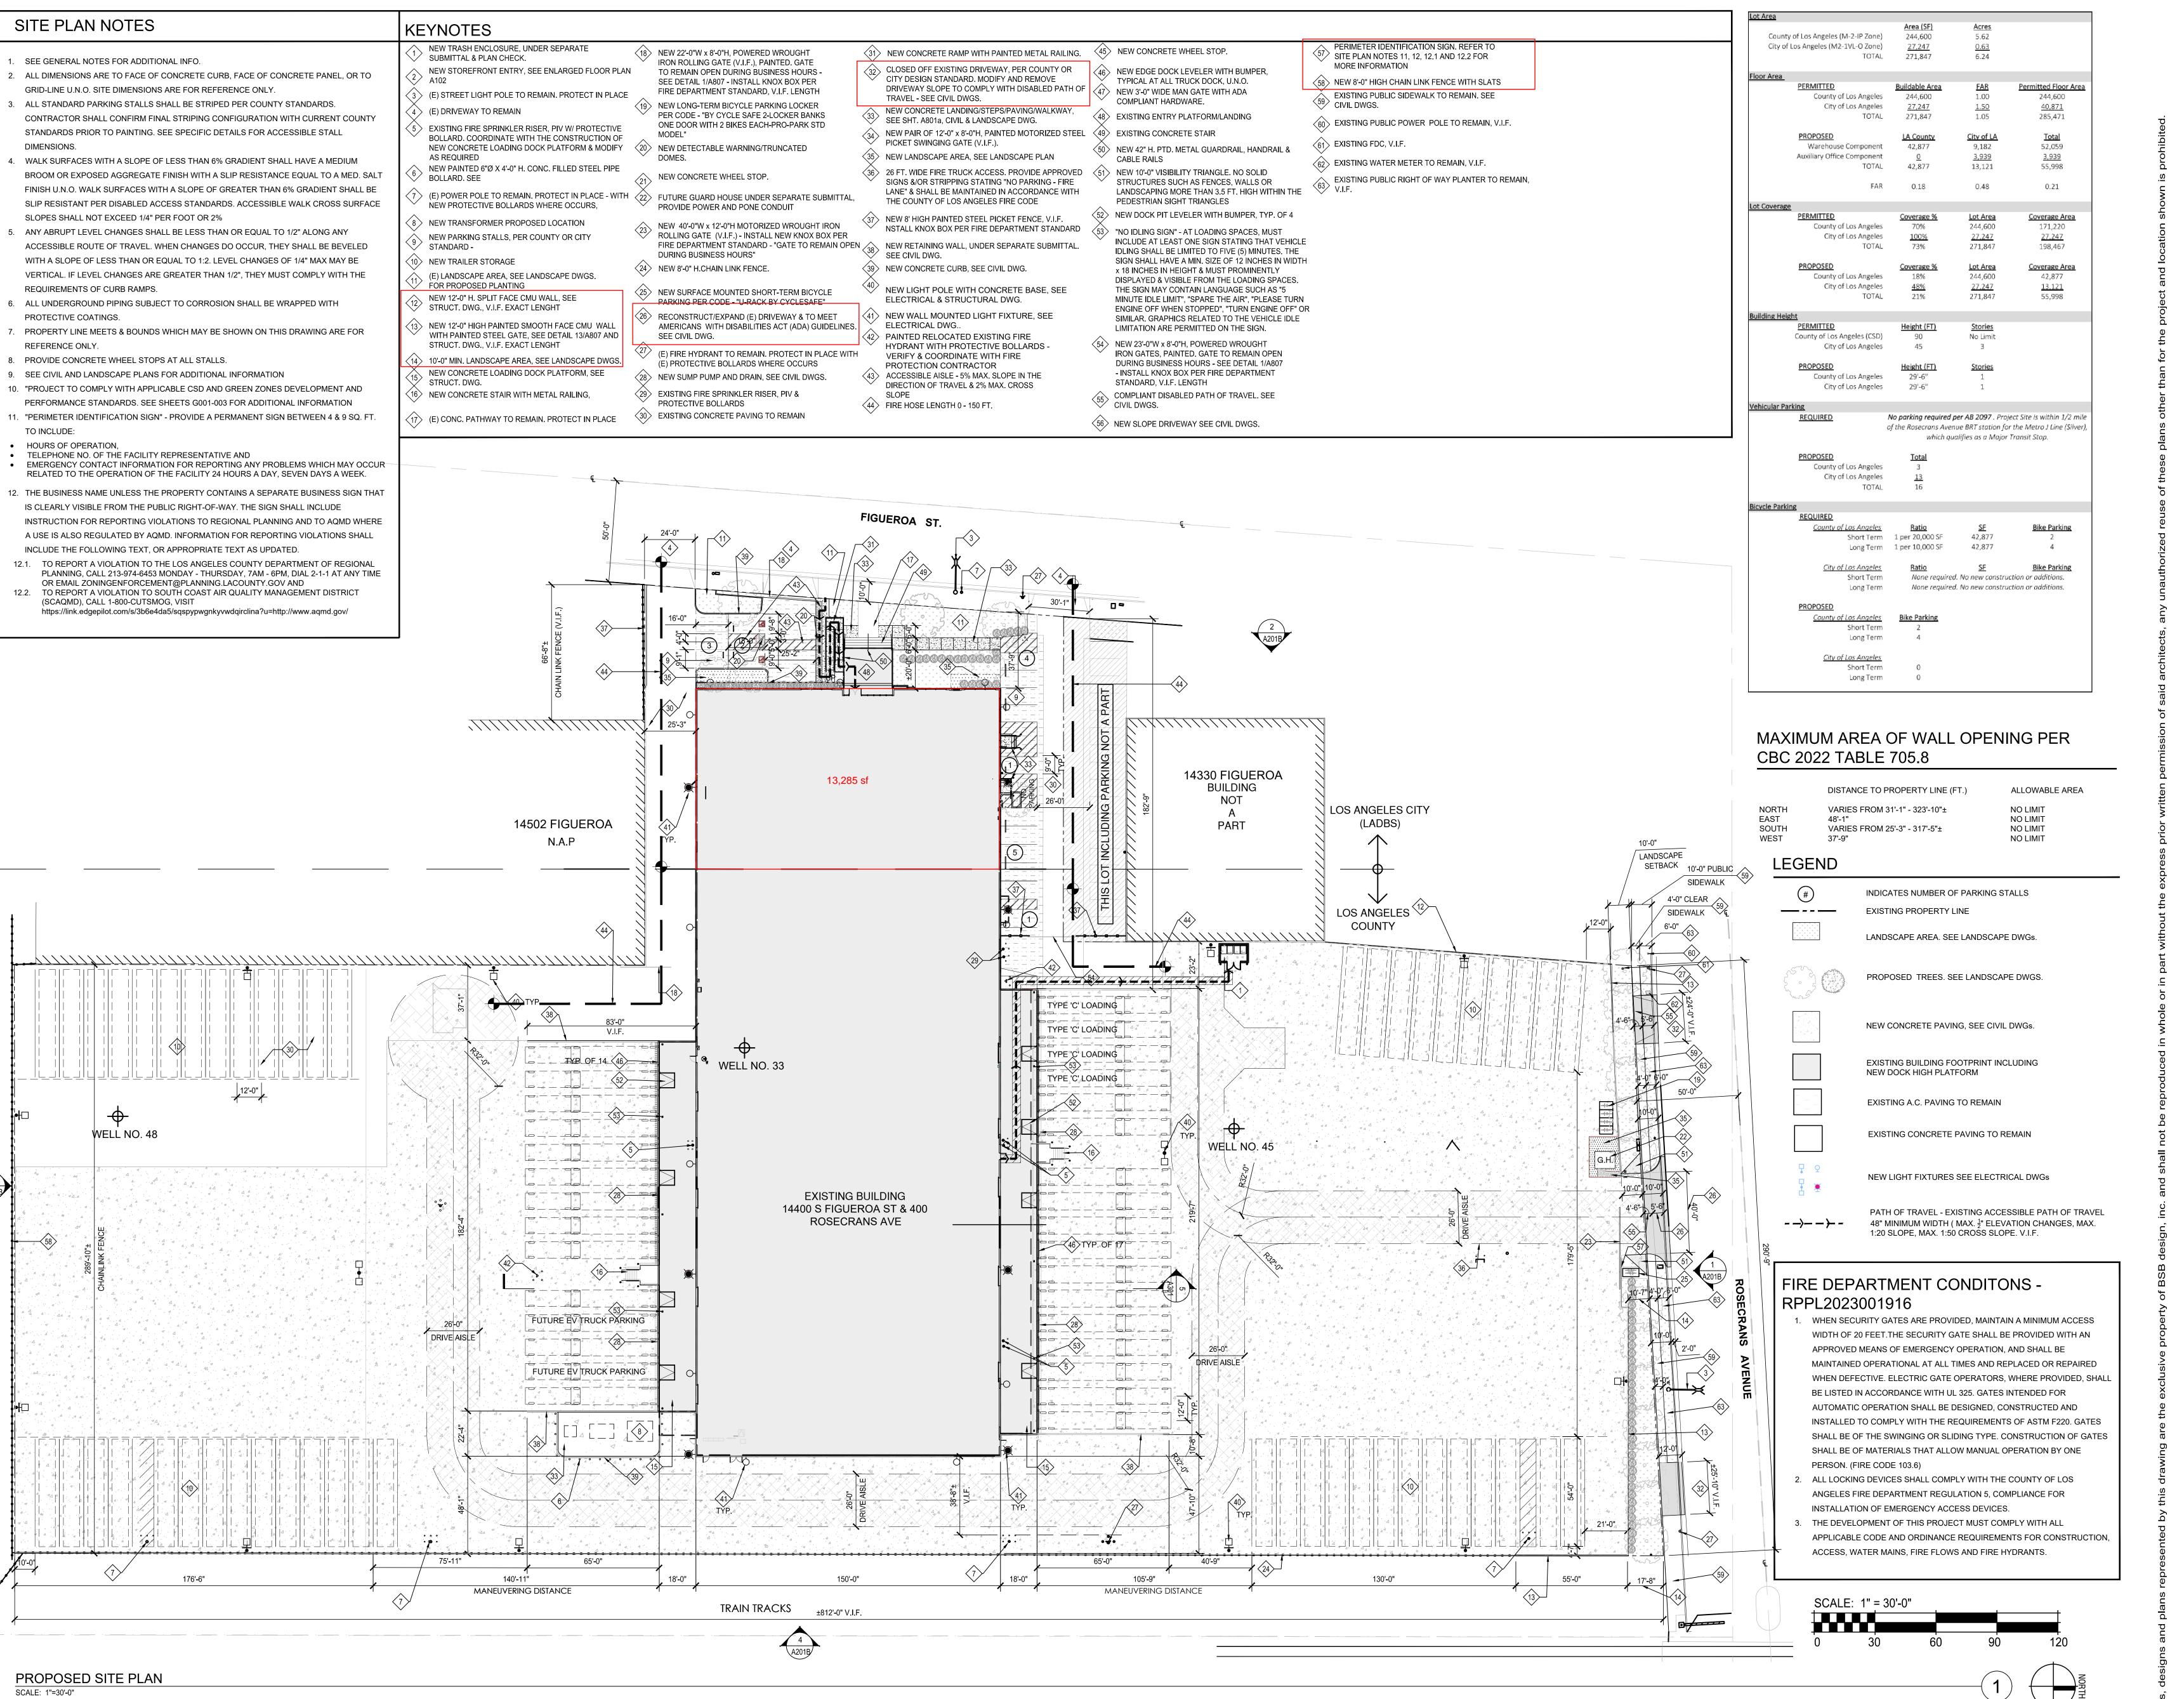

CM220364 JOB NO. **SUBMITTAL** DATE CITY SUBMITTAL 10/25/23 BID SET 03/22/24 BID ADDENDUM 'A' 04/17/24 PLANNING RESUBMITTAL 1 06/20/24

> REVISION DATE 02.06.24 公 LADBS & LA COUNTY CORR. 04/15/24 BID ADDENDUM 'A' BID ADDENDUM 'B' 04/23/24 06/21/24 BID ADDENDUM 'C'

LADBS STAMP

CLIENT:

Rexford Industrial

Xref \\Set-up\DS




BSBDESIGN.COM

SHEET TITLE SITE PLAN

SHEET NO. A001

JUNE 20, 2024 PLANNING RESUBMITTAL 1

03/22/2024

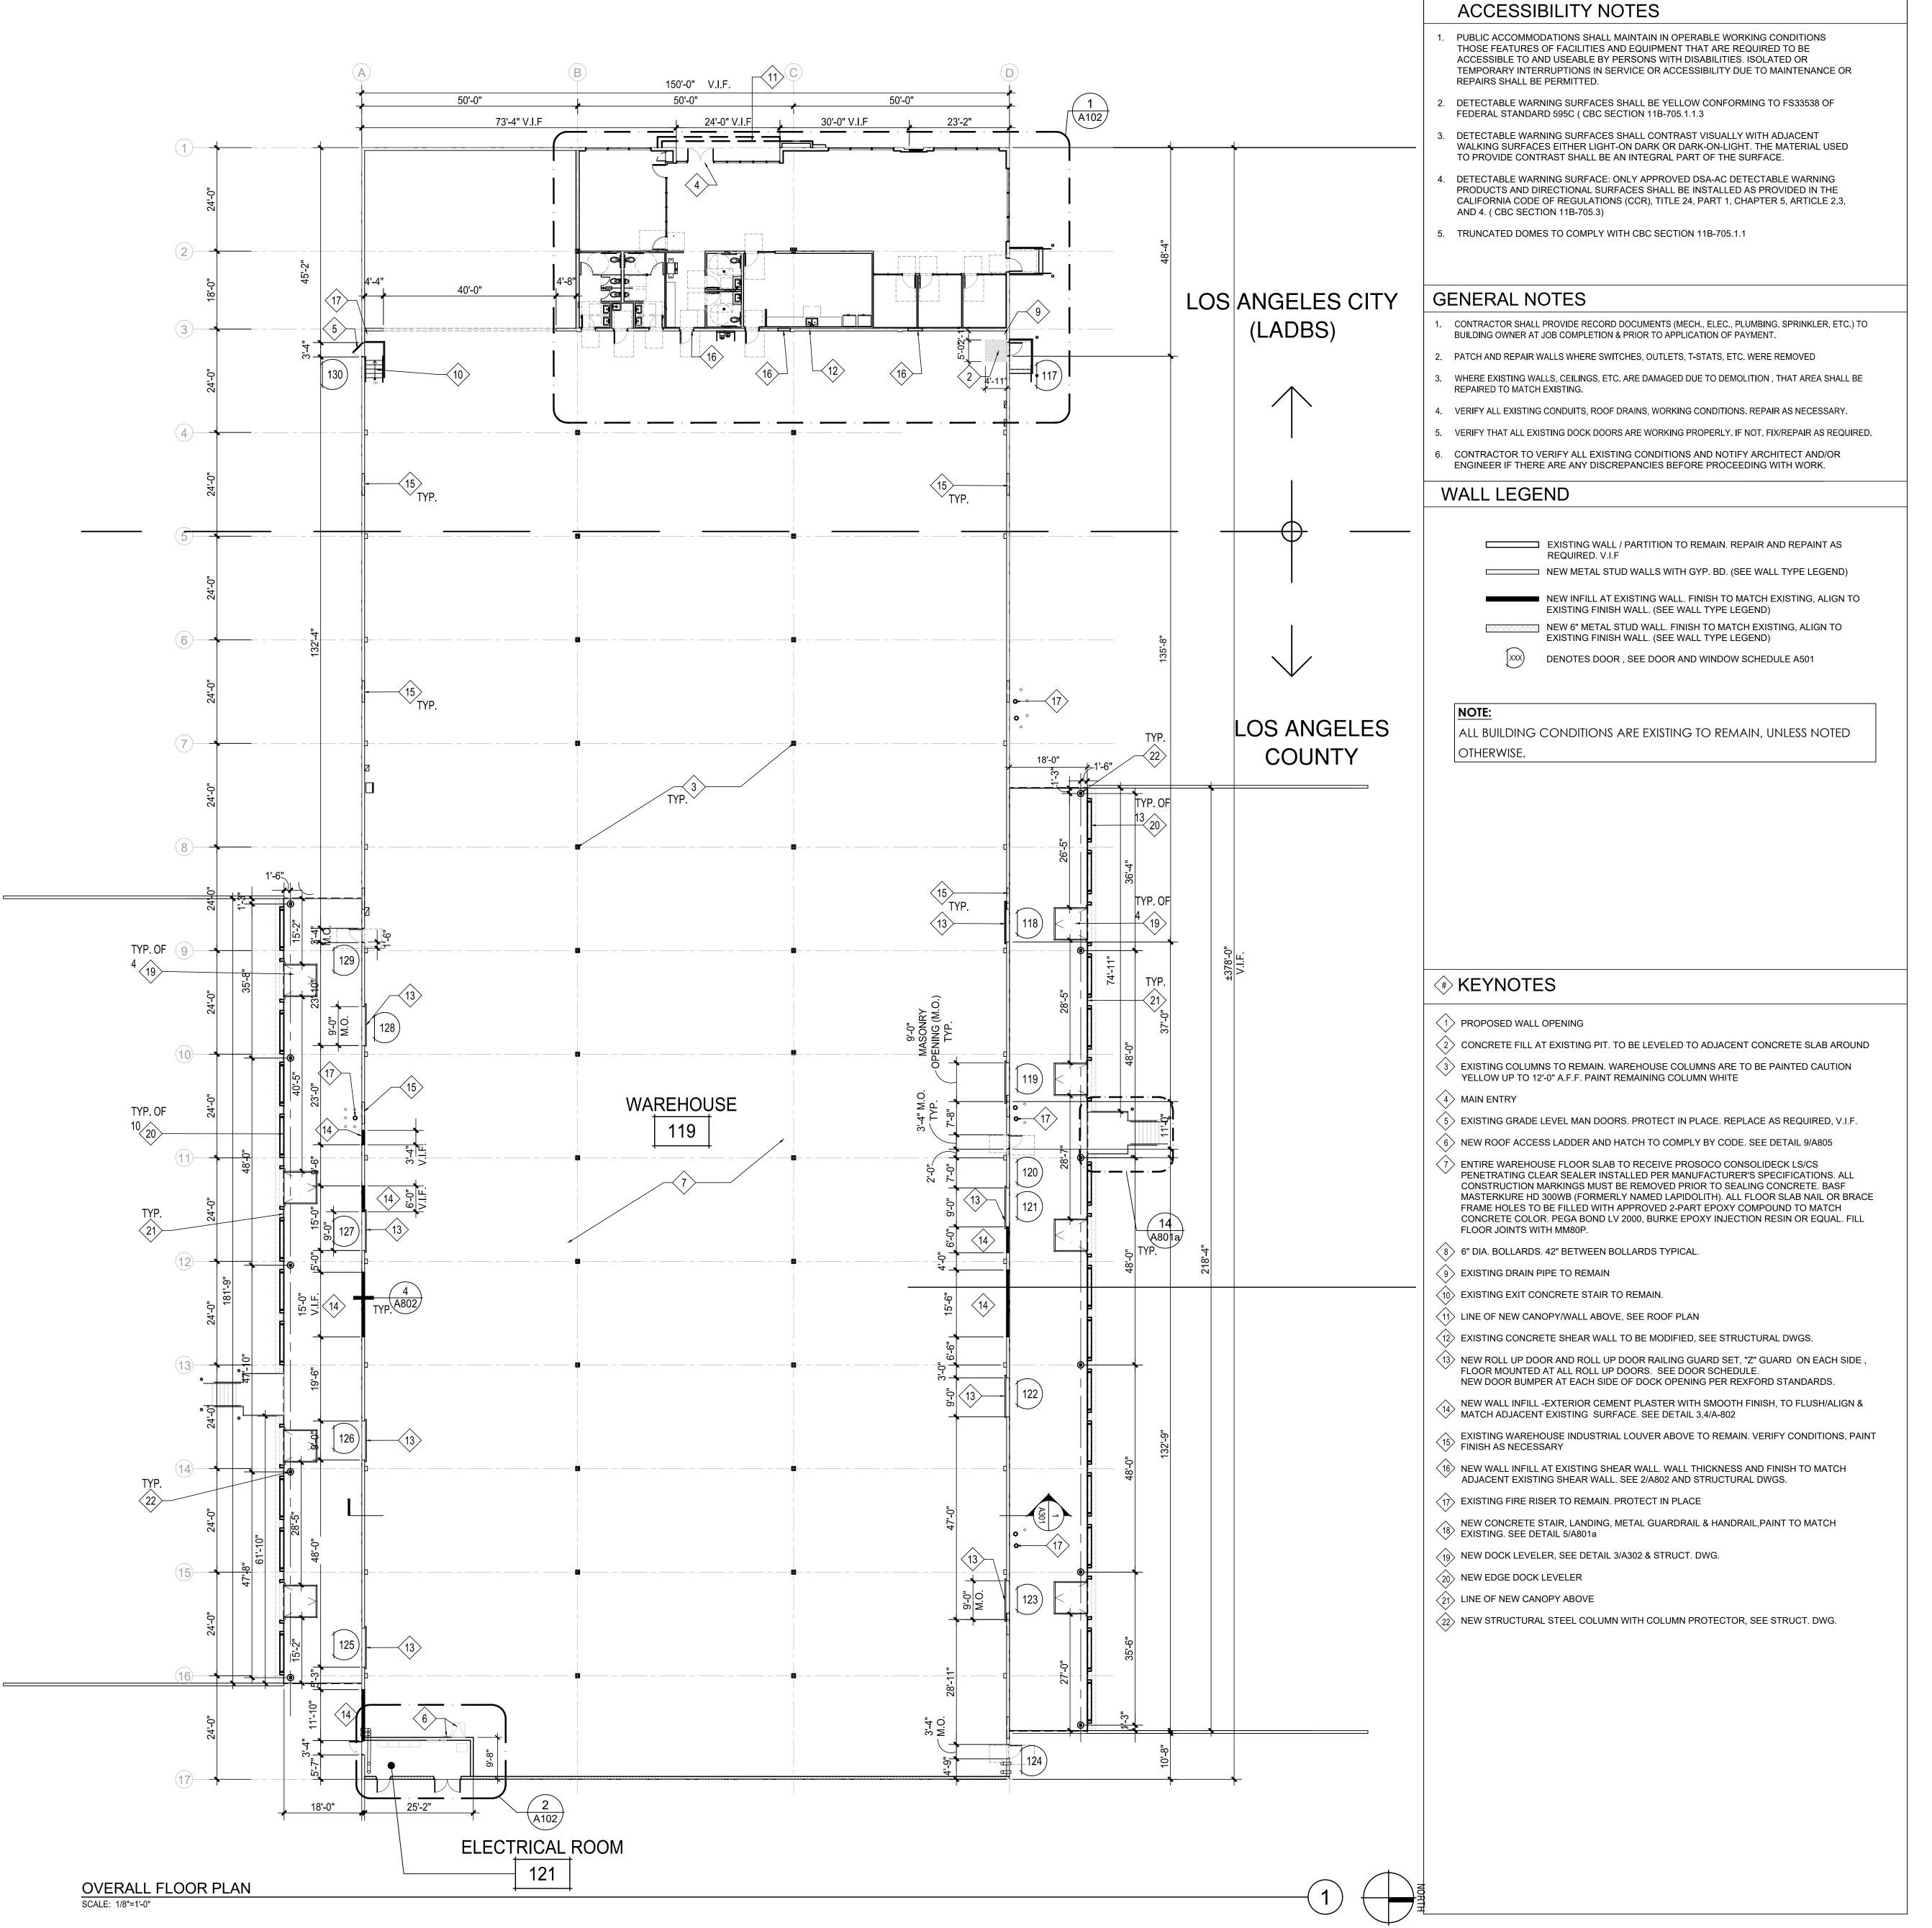

CM220364 JOB NO. DATE **SUBMITTAL**

CITY SUBMITTAL 10/25/23 BID SET 03/22/24 BID ADDENDUM 'A' 04/17/24 PLANNING RESUBMITTAL 1 06/20/24


> REVISION DATE 02.06.24 AC∖ LADBS & LA COUNTY CORR. 04/15/24 BID ADDENDUM 'A' 04/23/24 BID ADDENDUM 'B' 06/21/24 BID ADDENDUM 'C'

LADBS STAMP

CLIENT:



Rexford Industrial

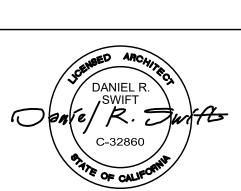




BSBDESIGN.COM

OVERALL FLOOR PLAN

A101 JUNE 20, 2024

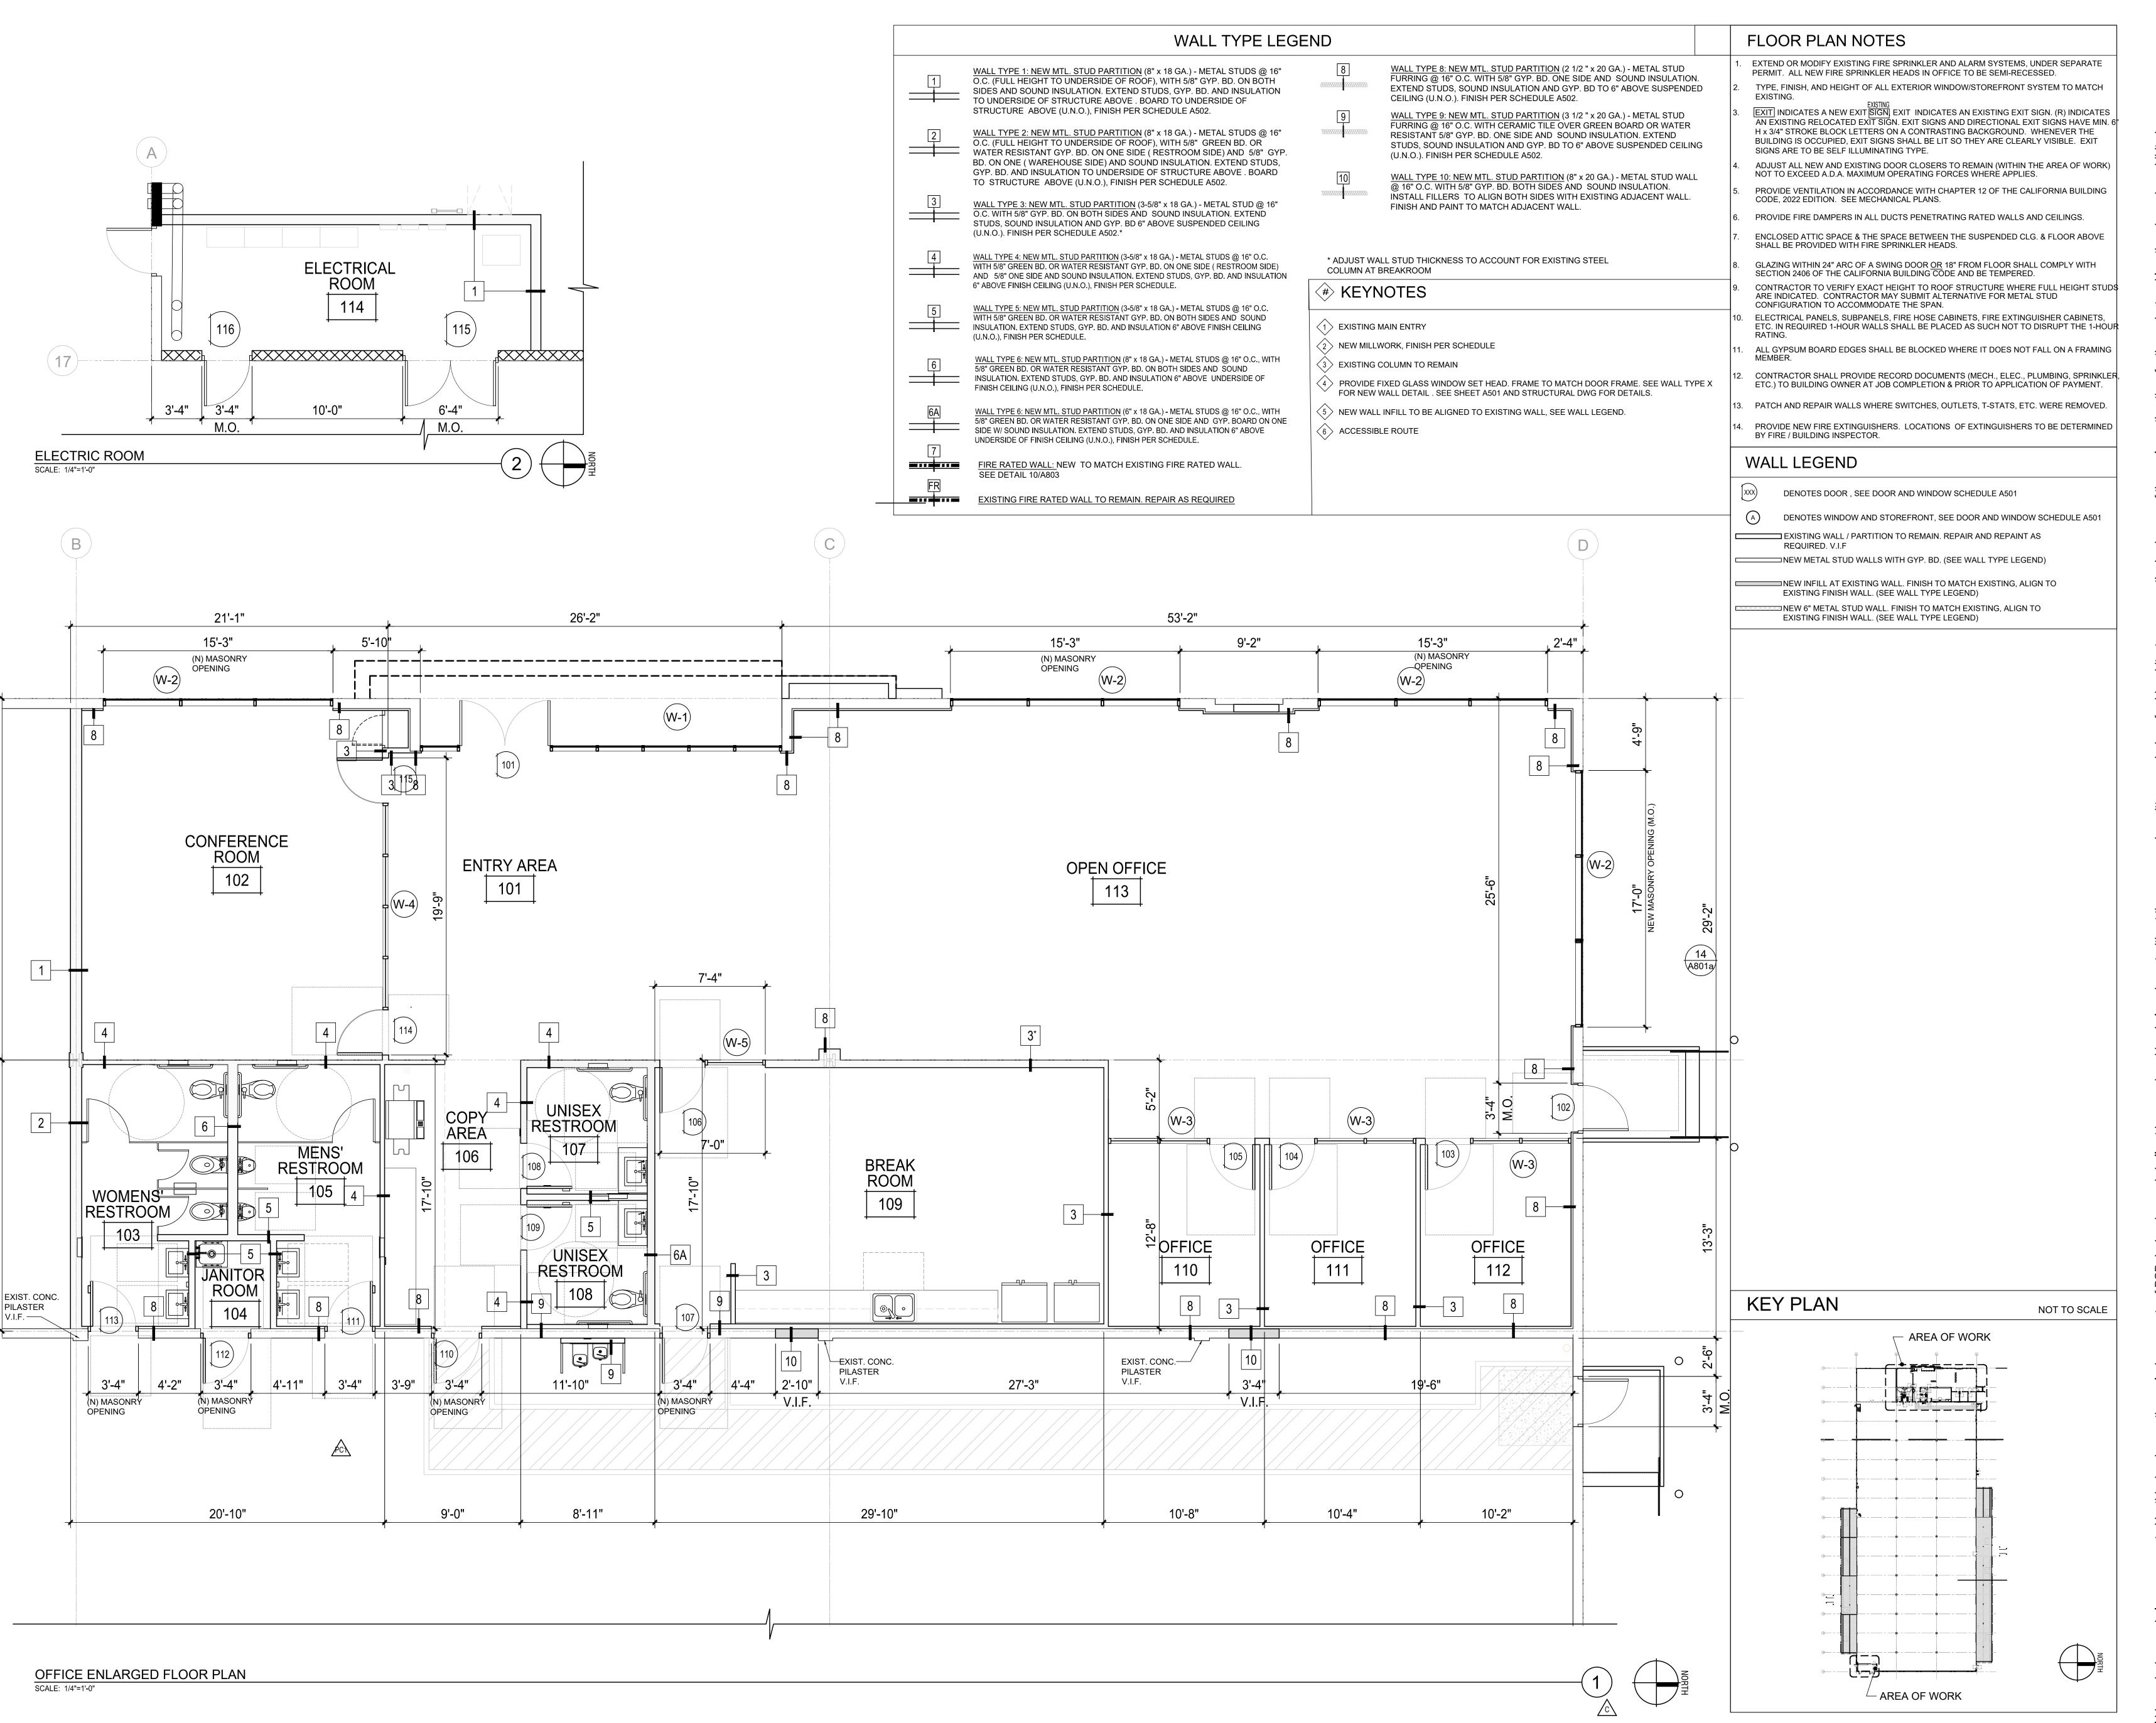

CM220364 JOB NO. **SUBMITTAL** DATE CITY SUBMITTAL 10/25/23 03/22/24 BID SET BID ADDENDUM 'A' 04/17/24 PLANNING RESUBMITTAL 1 06/20/24

REVISION DATE 02.06.24 AC∖ LADBS & LA COUNTY CORR. 04/15/24 BID ADDENDUM 'A' BID ADDENDUM 'B' 04/23/24 06/21/24 BID ADDENDUM 'C'

LADBS STAMP

CLIENT:

Rexford Industrial

11620 WILSHIRE LOS ANGELES, C






BSBDESIGN.COM

ENLARGED OFFICE FLOOR PLAN

SHEET NO. A102

JUNE 20, 2024

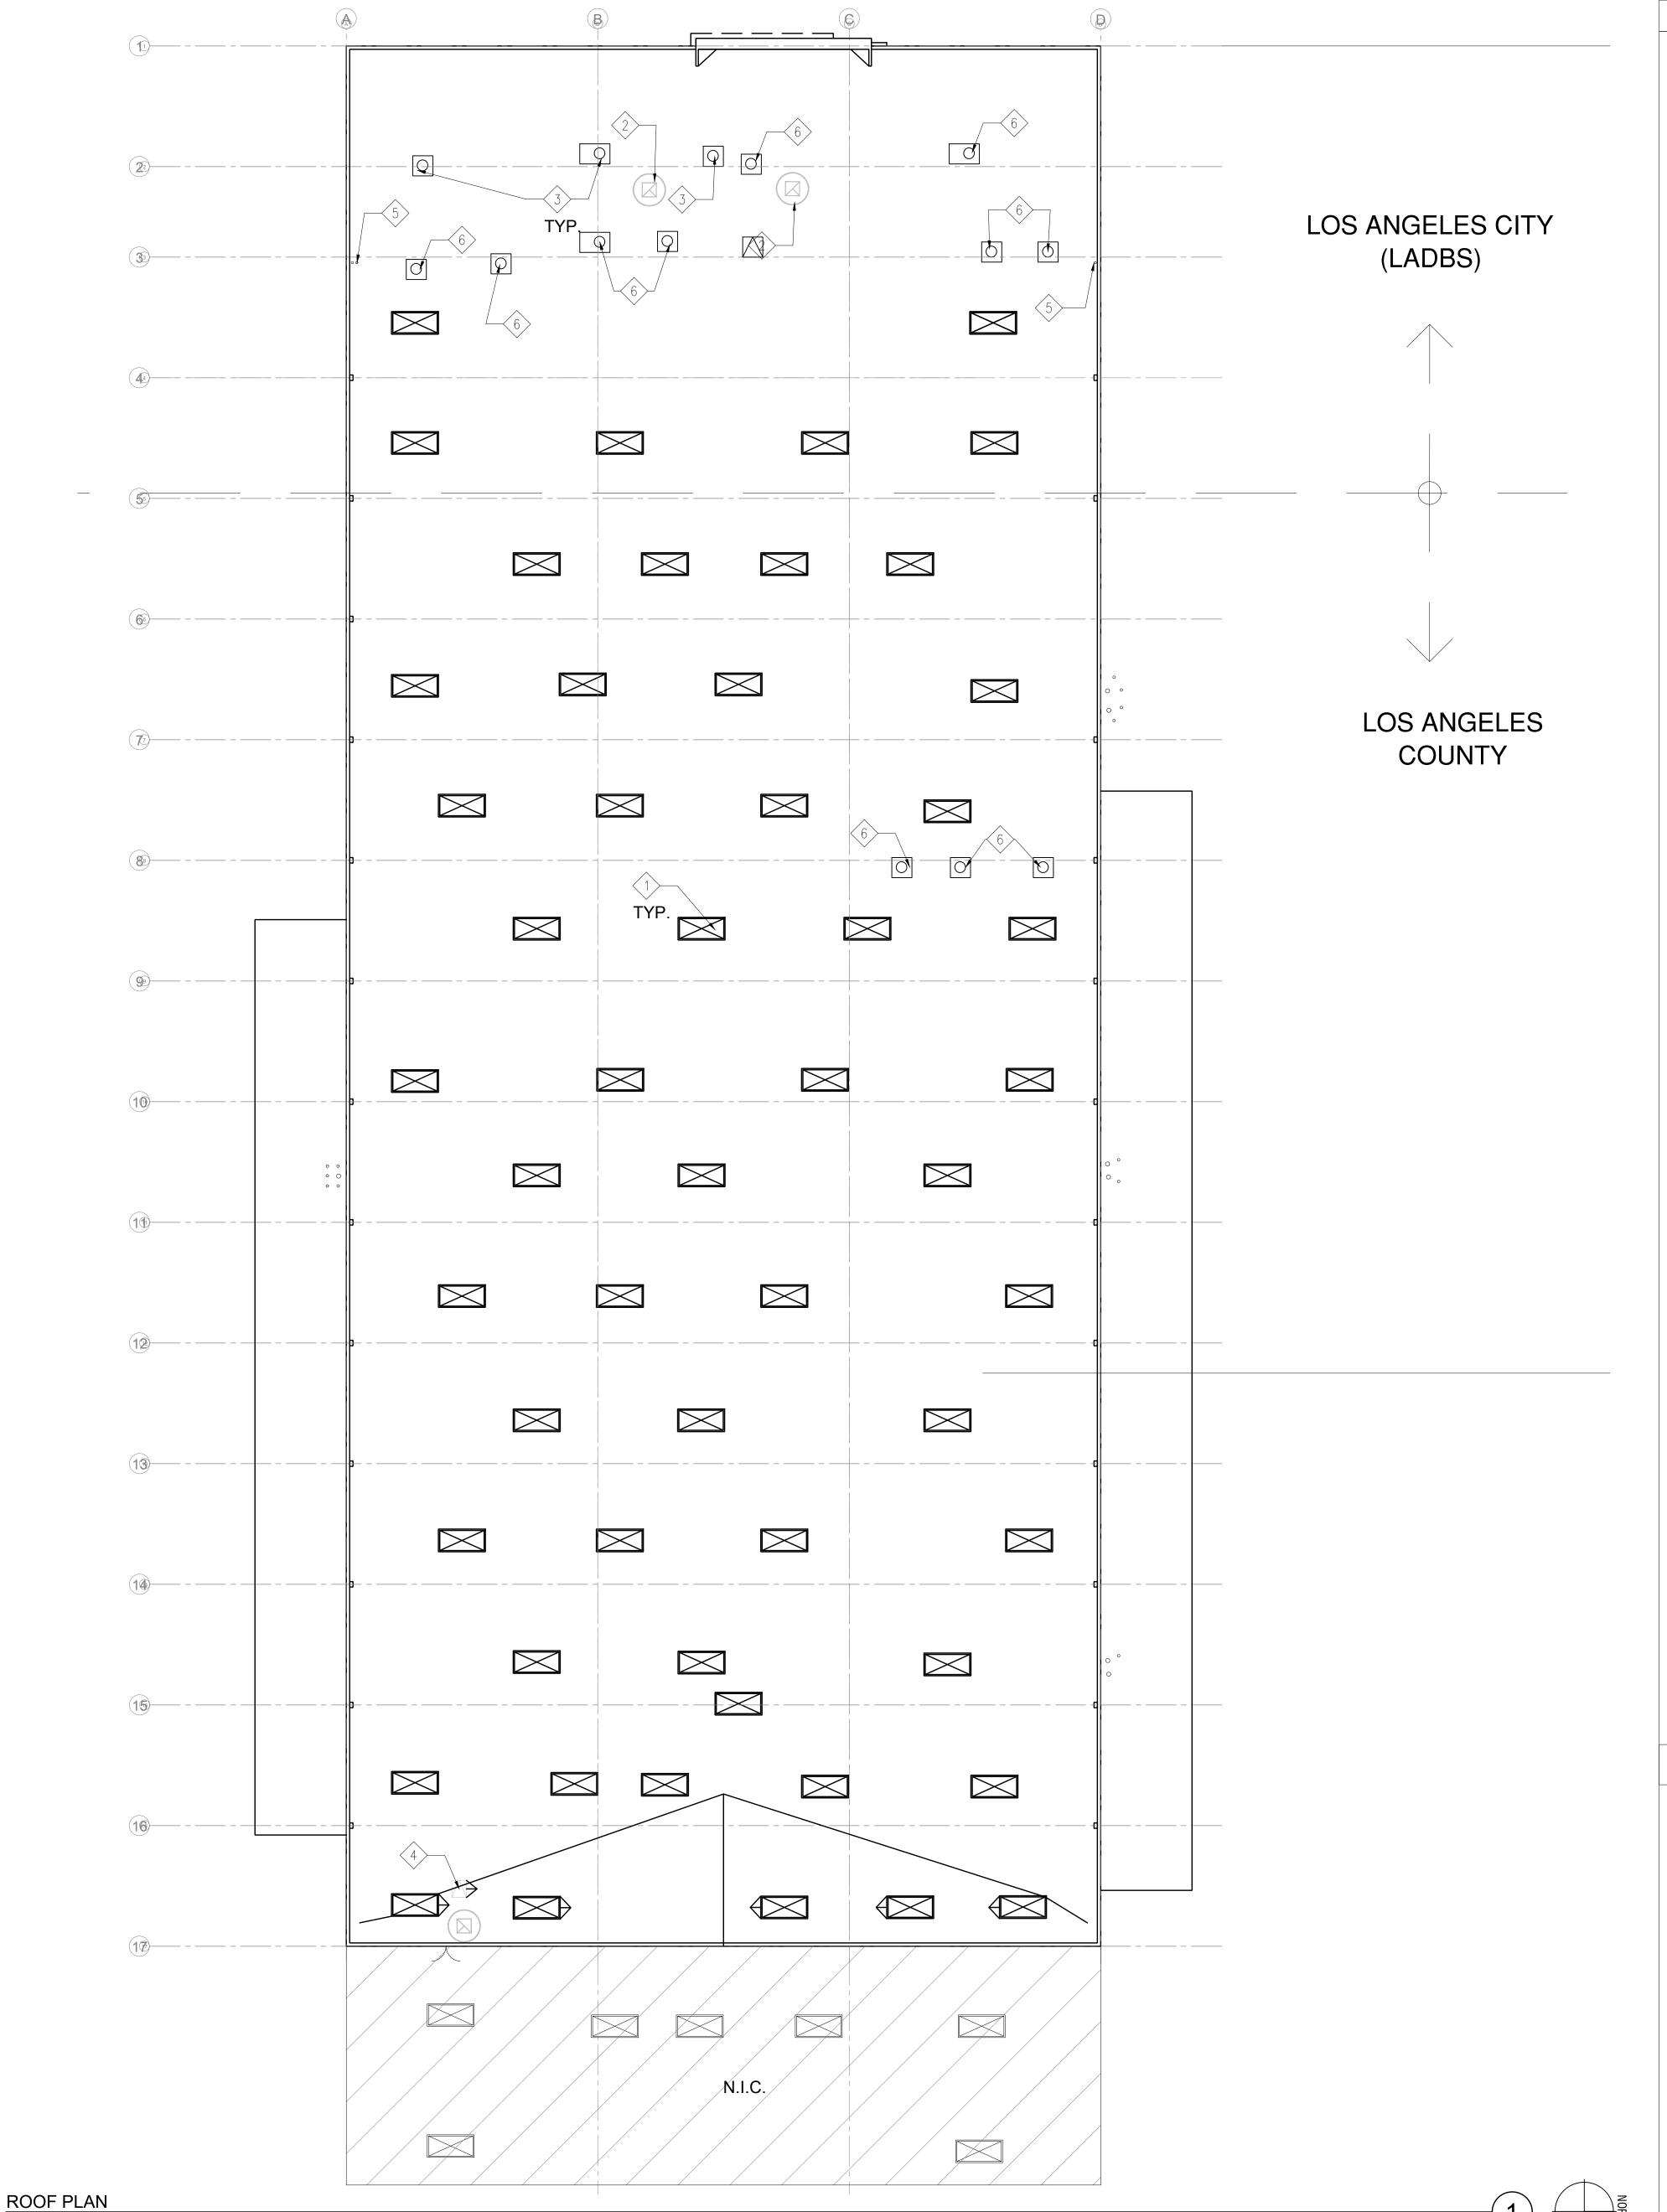

SCALE: 1/16"=1'-0"

ROOF PLAN GENERAL NOTES

MINIMUM ROOF SLOPE TO DRAIN IS $\frac{1}{4}$ " PER FOOT NEW HEAT PUMP UNIT. REFER TO MECHANICAL DRAWINGS

3. EXHAUST FAN. REFER TO MECHANICAL DRAWINGS

INFORMATION PROVIDED ARE A RESULT OF LIMITED FIELD VERIFICATION. CONTRACTOR TO FIELD VERIFY ALL EXISTING CONDITIONS INCLUDING THE LOCATIONS OF STRUCTURAL, MECHANICAL, ELECTRICAL AND PLUMBING PRIOR TO DEMOLITION.

8. ALL ROOF ELEVATIONS ARE REFERENCED FROM TOP OF FLOOR SLAB (FIN. FLR. ELEV. OF 0'-0") OR FROM DATUM LINE (0'-0") WHERE OCCURS, SEE BUILDING ELEVATIONS & SECTIONS TO LOCATE DATUM

WITH THE ROOFING MANUFACTURER'S RECOMMENDATIONS AND APPROVED DETAILS- SEE SPEC'S.

SINGLE PLY ROOFING MEMBRANE, ARE PROVIDED W/ POSITIVE DRAINAGE AT 1/4" PER FOOT MINIMUM PRIOR TO ROOFING.

12. ALL CRICKETS/FLASHING SHALL SLOPE A MINIMUM OF 1/2" PER FOOT.

13. PROVIDE CRICKETS/FLASHING AROUND ALL CURBED ROOF OPENINGS.

15. ALL MECHANICAL, PLUMBING AND ELECTRICAL TO RECEIVE PILLOW

17. PAINT ALL EXPOSED GALVANIZED STEEL PIPES, CONDUIT, ETC. VERIFY COLOR WITH ARCHITECT PRIOR TO PROCEEDING.

18. ALL ROOF MOUNTED EQUIPMENT (IE HOODS, VENTILATORS, ETC.) SHALL BE PAINTED WITH TWO(2) COATS OF EXTERIOR SEMI-GLOSS

19. PRIME AND PAINT ALL MISC. EXPOSED STEEL FABRICATIONS AND G.S. COPINGS, FLASHINGS, ETC., COLOR TO MATCH ADJACENT SURFACE, U.N.O., TYP.

PARAPETS, TYP. PROVIDE PLASTER CONTROL JOINTS IN ALL PLASTERED PARAPETS AT 10'-0" O.C. MAX. TYP.

ROOF TYPE

ROOF TYPE #1:

WEIGHT = 40# / 100 SF

TWO (2) PLIES OF 'GAF' VERSASHIELD FIRE RESISTANT ROOF DECK PROTECTION (OR EQ.), OR ONE (1) PLY OF VERSASHIELD SOLO FIRE RESISTANT SLIP SHEET (OR EQ.),

WEIGHT = 10# / 100 SF

TOTAL WEIGHT PER ROOFING SQUARE: = 50# / 100 SF

PROVIDE TAPERED FOAM OR PLYWOOD FRAMED CRICKETS AT HVAC UNITS, WING WALLS AND SIMILAR OBSTRUCTIONS, AS REQUIRED FOR FLOW TO DRAIN.

MISC. METAL DETAILS, FABRICATION PRACTICES AND INSTALLATION METHODS SHALL CONFORM TO THE APPLICABLE REQUIREMENTS OF THE 'SHEET METAL AND AIR CONDITIONING CONTRACTORS NATIONAL ASSOCIATION, INC.' (SMACNA) MANUAL, LATEST ISSUE. ANY METAL COPINGS, FLASHINGS, ETC., OTHER THAN THAT PROVIDED BY 'GAF', ARE NOT COVERED UNDER THE 'GAF' WARRANTY.

LISTS THE REFLECTANCE AND EMITTANCE TESTED IN ACCORDANCE WITH CRRC-1.

EXECUTES

- (1) EXISTING ROOF SKYLIGHT TO BE REPAIRED, RE-PAINTED AS REQUIRED, V.I.F. ADD NEW BURGLAR BARS, PAINT FINISH
- (2) EXISTING EXHAUST FANS/VENTS TO REMAIN, V.I.F. SEE MECHANICAL DRAWINGS.
- EXISTING MECHANICAL UNITS & EQUIPMENT PER MECHANICAL DRAWINGS.
- NEW ROOF ACCESS HATCH, SEE DETAIL 09/A805
- EXISTING ROOF DRAIN TO REMAIN. V.I.F. REPAIR, CLEAN AS REQUIRED
- EXISTING MECHANICAL UNITS TO BE ABANDONED, CAP AND PATCH AS REQUIRED, SEE MECHANICAL DRAWINGS.

4. WHERE EXISTING ROOF, ETC. ARE DAMAGED DUE TO DEMOLITION OR NEW CONSTRUCTION, THAT AREA SHALL BE REPAIRED TO MATCH EXISTING.

5. REMOVE ANY UNNECESSARY OR ABANDONED DUCTWORK, EQUIPMENT, ETC. WITHIN THE AFFECTED PORTIONS OF DEMOLITION.

6. PATCH & REPAIR EXISTING ROOF, ROOF PARAPET TO MATCH EXISTING, WHERE OVERFLOW SCUPPER WAS REMOVED AND NEW OVERFLOW DRAIN WERE PROVIDED.

9. ALL ROOF WORK SHALL BE PERFORMED IN STRICT ACCORDANCE

10. THE CONTRACTOR SHALL VERIFY THAT ALL AREAS TO RECEIVE

11. VERIFY SIZES AND LOCATIONS OF ALL OPENINGS, PLATFORMS, ETC., WITH RESPECTIVE CONTRACTORS.

14. ALL ROOF DIMENSIONS ARE MEASURED TO THE FACE OF SHEATHING,

16. GENERAL CONTRACTOR TO PROVIDE ROOF JACKS AT ALL EXPOSED ROOF PENETRATIONS. SEE 5/A701

BLOCKS AS REQUIRED, MAX. 4'-0" APART.

PAINT. VERIFY COLOR WITH ARCHITECT PRIOR TO PROCEEDING.

20. PRIME AND PAINT INTERIOR (ROOF SIDE) SURFACE OF PLASTERED

GAF' THERMOPLASTIC POLYOLEFIN (TPO) ROOF SYSTEM, CLASS 'A' ASSEMBLY (UL #TGFU.R1306), WITH MECHANICALLY FASTENED SINGLE PLY 'GAF' EVERGUARD 60 MIL TPO MEMBRANE AND HEAT WELDED SEAMS, OVER A FIRE RESISTANT SLIP SHEET, ON PLYWOOD DECK. SCREW FASTENERS THROUGH BOARDS AND ROOF DECK, SPACED AS REQUIRED FOR FACTORY MUTUAL (FM) I-60 WIND UPLIFT MINIMUM (FIELD, PERIMETER, AND CORNERS). PROVIDE ALL APPURTENANCES NECESSARY FOR A COMPLETE SYSTEM. INSTALL PER THE MOST CURRENT 'GAF' GUIDE SPECIFICATION, USING 'GAF' APPROVED ROOFING APPLICATORS. PROVIDE A 20-YEAR STANDARD 'GAF' WARRANTEE FOR MATERIALS AND LABOR. SUBMIT DATA ON ROOF ASSEMBLY

EVERGUARD 60 MIL TPO MEMBRANE, MECHANICALLY FASTENED WITH DRILLTEC PLATES. CRRC #0676-0001. SOLAR REFLECTANCE VALUE = 0.76, THERMAL EMITTANCE VALUE = 0.90, SRI = 94. COLOR: "WHITE". MAX. SLOPE SHALL NOT EXCEED 2-1/2: 12.

MECHANICALLY FASTENED.

PROVIDE MISC. FLASHINGS FOR PIPE AND CONDUITS PENETRATIONS PER 'GAF' RECOMMENDATIONS. COORD. WITH ELECT. AND PLUMB. DW'GS.

ALL COOL ROOF PRODUCTS SHALL HAVE A CLEARLY VISIBLE PACKAGING LABEL THAT



CM220364

DATE

10/25/23

03/22/24

04/17/24

06/20/24

DATE

02.06.24

04/15/24

04/23/24

06/21/24

JOB NO.

BID SET

SUBMITTAL

CITY SUBMITTAL

BID ADDENDUM 'A'

REVISION

LADBS STAMP

CLIENT:

Rexford Industrial

PLANNING RESUBMITTAL 1

A LADBS & LA COUNTY CORR.

BID ADDENDUM 'A'

BID ADDENDUM 'B'

BID ADDENDUM 'C'



BSBDESIGN.COM

ROOF PLAN

SHEET TITLE

SHEET NO. A131

JUNE 20, 2024

# MATERIAL/ PAINT CALLOUTS	# ELEVATIONS KEYNOTES
1 SW 6887 NAVEL 2 EXISTING BRICK FACADE TO BE PAINT SW 7674 PEPPERCORN 3 SW 7673 PEWTER CAST 4 SW 7069 IRON ORE 5 SW 7003 TOQUE WHITE	1 PROPOSED TRASH ENCLOSURE 2 9'-0" X 10'-0" VERTICAL LIFT DOOR WITH DOCK BUMPERS, TYP. 3 LOADING DOCKS 4 PROPOSED RAMP WITH CABLE RAILING 5 EXISTING ENTRY 6 NEW ALUCOBOND CANOPY 7 PROPOSED STOREFRONT WINDOWS 8 CONCRETE STAIRS 9 NEW WALL PACKS 10 FIRE RISER 11 NEW LIGHT POLES



SUBMITTAL

CITY SUBMITTAL

10/25/23

REVISION

DATE

LADBS STAMP

CLIENT:


CM220364

JOB NO.



REXFORD INDUSTRIAL REAL
14400 S FIGUEROA ST.
GARDENA, CA 90248

REXFORD INDUSTRIAL REALTY
11620 WILSHIRE BOULEVARD, Suite 610
LOS ANGELES, CA 90024

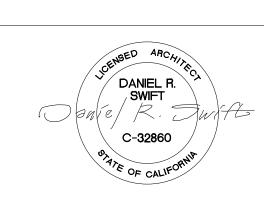




SHEET TITLE

RENDERED EXTERIOR ELEVATIONS

SHEET NO. **A201A**

February 06, 2024

SUBMITTAL SET 02/06/2024

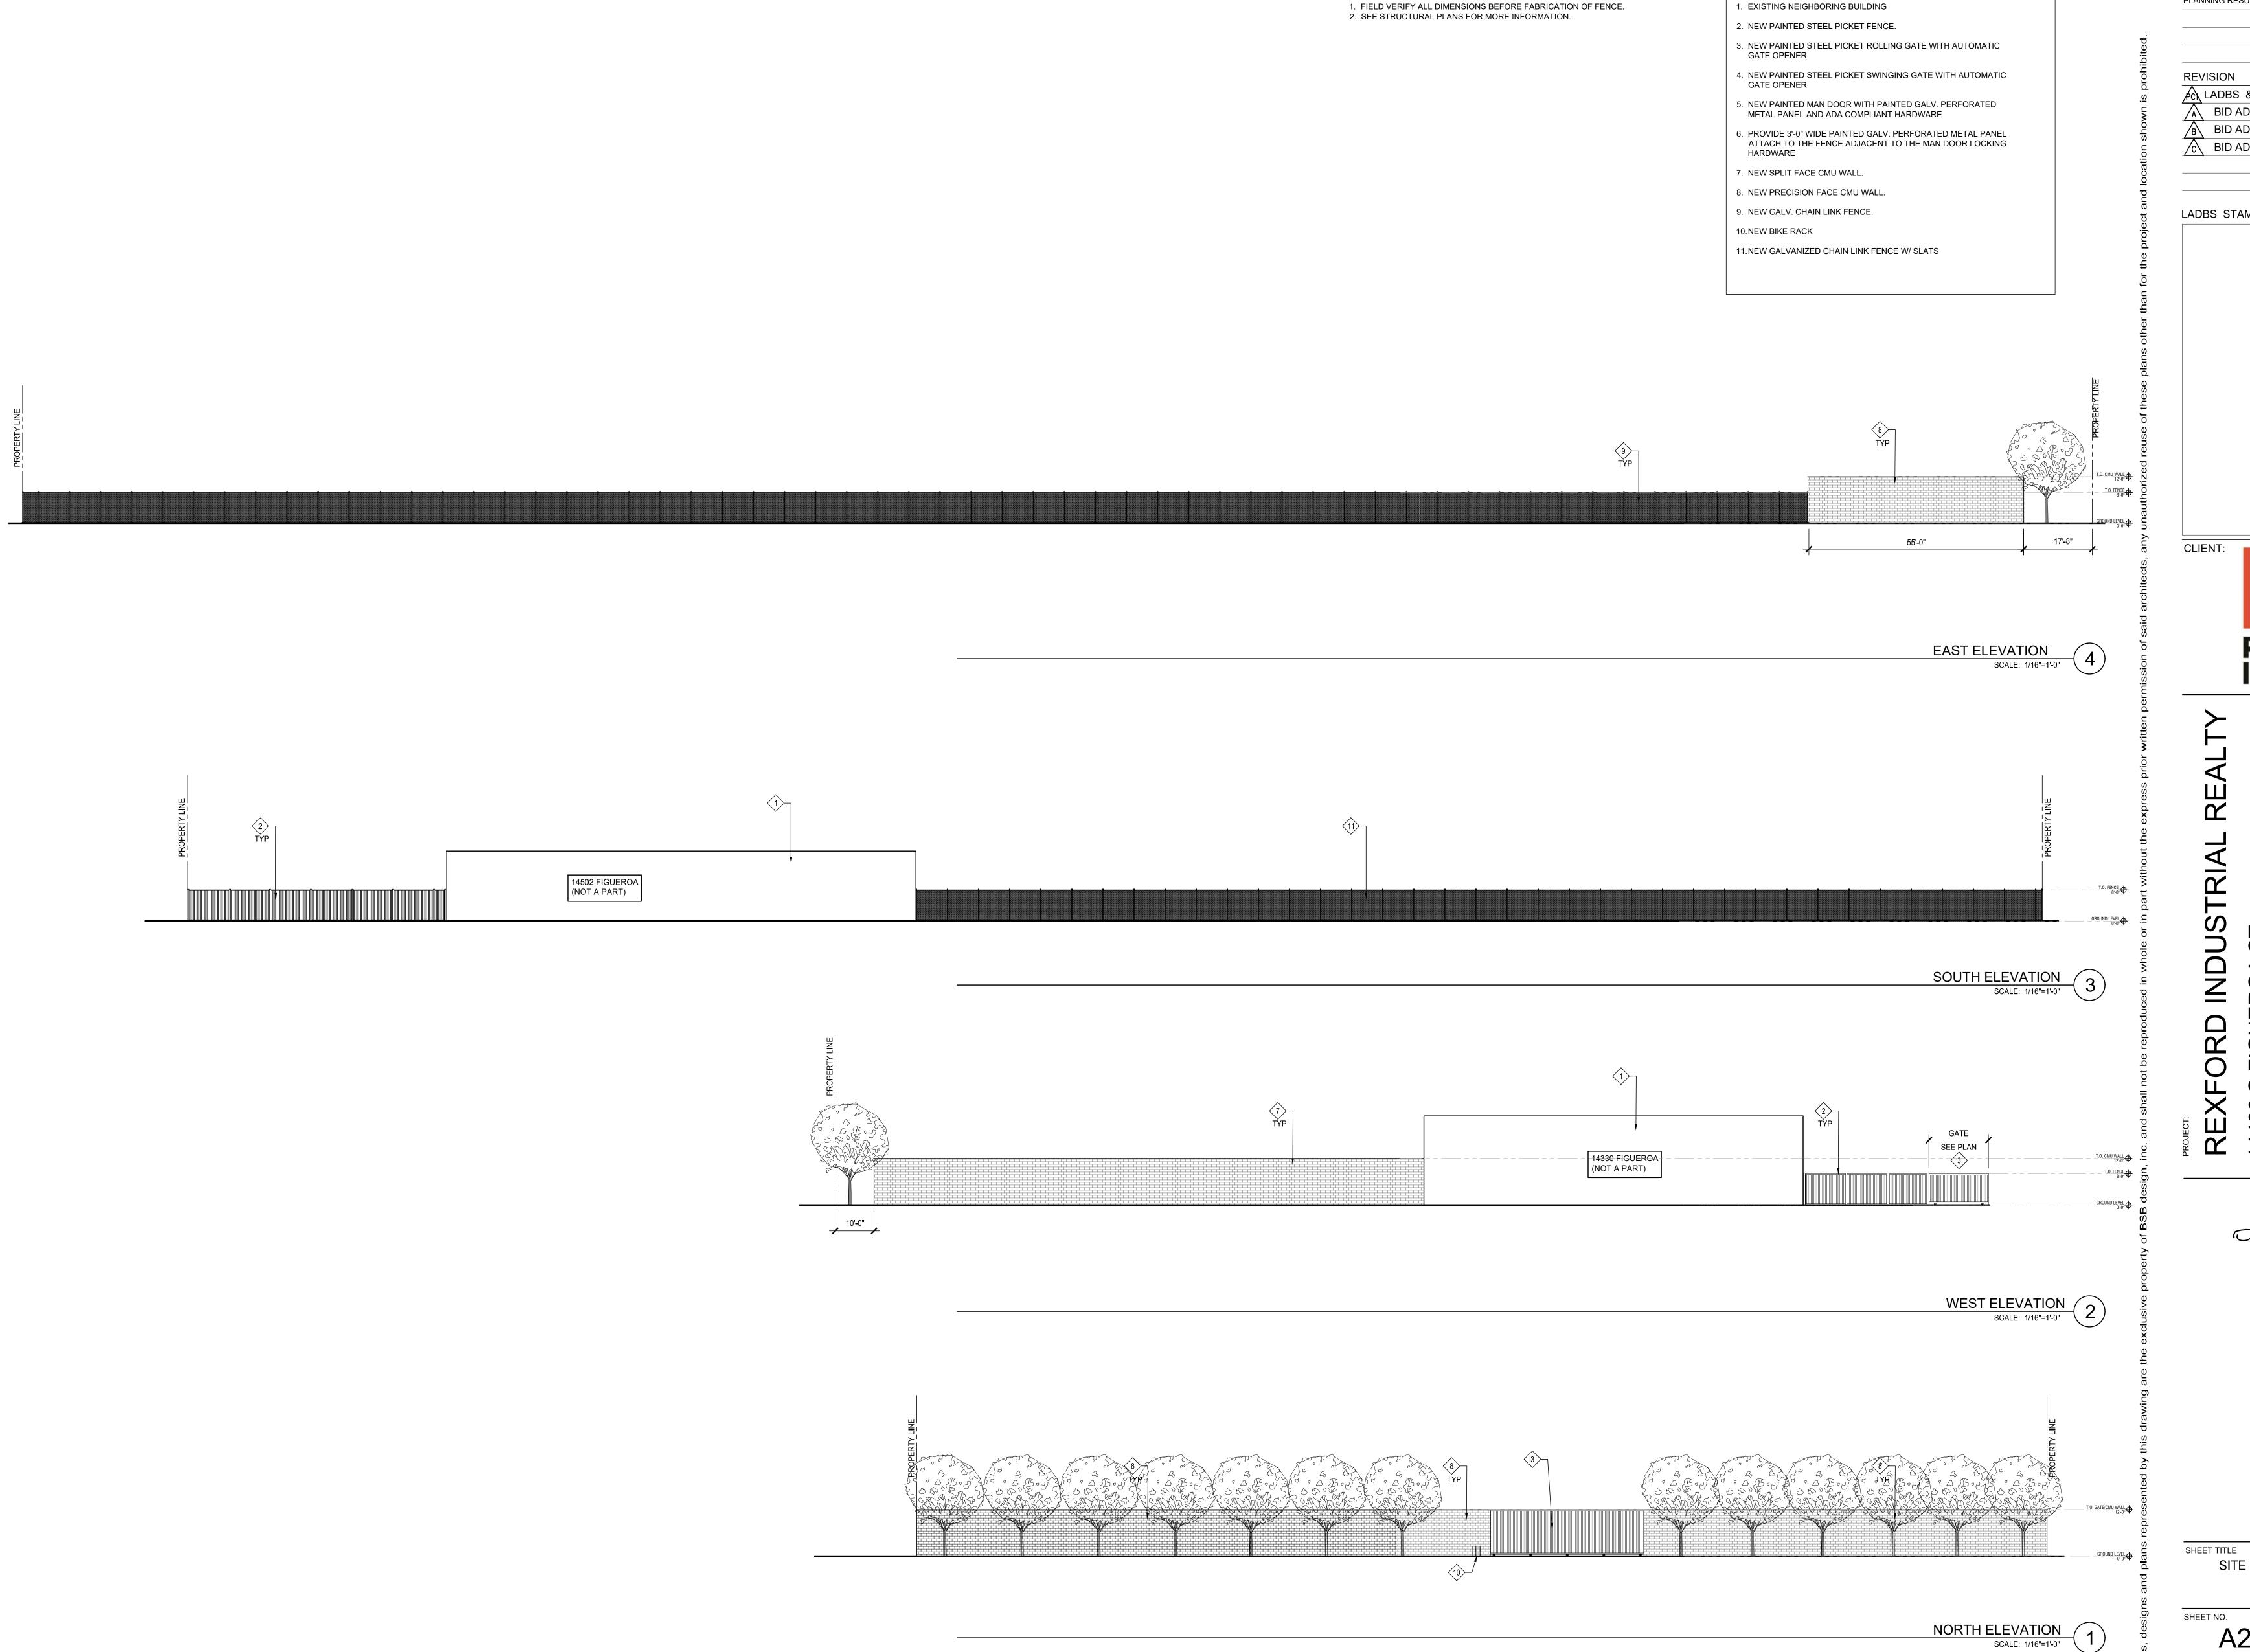

ELEVATIONS GENERAL NOTES

ELEVATIONS KEYNOTES

JOB NO.	CM220364
SUBMITTAL	DATE
CITY SUBMITTAL	10/25/23
BID SET	03/22/24
BID ADDENDUM 'A'	04/17/24
PLANNING RESUBMITTAL 1	06/20/24


REVISION	DATE
LADBS & LA COUNTY CORR.	02.06.24
BID ADDENDUM 'A'	04/15/2
BID ADDENDUM 'B'	04/23/24
BID ADDENDUM 'C'	06/21/24

LADBS STAMP



Rexford Industrial

REXFORD INDUSTRIAL 11620 WILSHIRE BOULEV LOS ANGELES, CA 90024 14400 S GARDEN

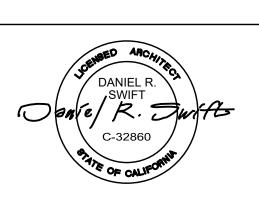



SITE ELEVATIONS

A201B

JUNE 20, 2024



1 9'-0" X 10'-0" VERTICAL LIFT DOOR WITH DOCK BUMPERS, TYP.
2 LOADING DOCKS

TYP. 1			2	
D	С	В	A	BUILDING HEIGHT ← 29° - 4° + 1/-
				T.O. PARAPET 25' - 6"
70'-0"			15'-0" 70'-0"	LEVEL 2 12° - 0°
				BUILDING SECTION 1
				1/16" = 1'-0"

JOB NO. CM220364

SUBMITTAL DATE

CITY SUBMITTAL 10/25/23

REVISION DATE

LADBS STAMP

CLIENT:



INDUSTRIAL

xford dustrial ________

REXFORD INDUSTRIAL F
11620 WILSHIRE BOULEVARD, Suite 610
LOS ANGELES, CA 90024

REXFORD

14400 S FIGUE

CLIENT:

CLIENT:

CLIENT:

REXFORD I

REXFORD I



BSBDESIGN.COM

SHEET TITLE

BUILDING SECTION

SHEET NO.

A301

February 06, 2024

SUBMITTAL SET

02/06/2024

22.84.010 - Purpose.

The Green Zone Districts are established to promote environmental justice in communities that are disproportionately affected by toxic pollutants and contaminants generated from various land uses over time. This Chapter provides regulations and procedures for new and existing land uses to ensure that such land uses will be operated in consideration of the surrounding sensitive uses as defined in Chapter 22.14 (Definitions), minimizing potential adverse health and safety impacts, and promoting clean industrial uses. The Green Zone Districts are identified as the unincorporated communities of Avocado Heights, East Los Angeles, East Rancho Dominguez, Florence-Firestone, South San Jose Hills, West Whittier-Los Nietos, Walnut Park, West Athens-Westmont, Willowbrook, West Carson, and West Rancho Dominguez-Victoria.

(<u>Ord. 2022-0023</u>§ 25, 2022.)

22.84.020 - Applicability.

- A. General Applicability. This Chapter applies to uses that are located in permitted zones within the Green Zone Districts, as depicted on Figure 22.84.050-A, and meet all criteria described below:
- 1. Types of uses.
 - a. New and existing, legally-established uses listed under the Industrial Uses category, except for the airport-related sub-category, in Table 22.22.030-B (Principal Use Regulations for Industrial Zones), including airports, heliports, helistops, and landing
 - b. New and existing, legally-established uses listed under Recycling and Solid Waste Uses category in Table 22.22.030-B (Principal Use Regulations for Industrial Zones).
 - c. New and existing, legally-established uses listed under the Vehicle-Related Uses, in Table 22.22.030-B (Principal Use Regulations for Industrial Zones), except for the vehicle sales and rentals sub-category. Supply stores under the vehicle services sub-category that are within fully enclosed buildings are also not subject to this Chapter.
 - d. New automobile service stations and new drive-through establishments as defined in <u>Chapter 22.14</u> (Definitions), listed in Table 22.20.030-B (Principal Use Regulations for Commercial Zones).

2. Location of uses.

- a. Any lots, or portion thereof, that contain the uses described in Subsections 1.a, 1.b, 1.c, or 1.d, above, and are located within a 500-foot radius of a lot that contains a sensitive use as defined in Chapter 22.14 (Definitions) as of the effective date of this ordinance, shall comply with the requirments in sections 22.84.030, 22.84.040, and 22.84.050, below.
- b. For the purpose of this Chapter, all requirements shall also apply to such lots, or portions thereof, if the sensitive use within a 500-foot radius is located within an incorporated area and is also a residential use.
- 3. Prohibited uses. The following uses are prohibited within a 500-foot radius of a lot containing
- a sensitive use in Green Zone Districts, except where noted:

a. Acid manufacture.

- b. Anaerobic digestion facility, except as an accessory to a legally-established use that processes waste generated on-site only.
- c. Auto dismantling (outdoor operation).
- d. Cement, lime, gypsum, or plaster of Paris manufacture.
- e. Chipping and grinding.
- f. Combustion or non-combustion biomass conversion facility, except for a non-combustion biomass conversion facility that processes waste generated on-site only.
- g. Composting facility, except for green waste composting only.
- h. Compressed natural gas manufacture.
- i. Construction and demolition facility, recycling.
- j. Conversion technology facility, recycling, or solid waste.
- k. Distillation of bones.
- Drop hammers.
- m. Explosives.
- n. Forging works.
- o. Fertilizer manufacture, except accessory composting of on-site generated waste associated with a legally-established commercial or agricultural use.
- p. Gas manufacture, except accessory anaerobic digestion of on-site generated waste associated with a legally-established commercial or agricultural use.
- q. Glue manufacture.
- r. Inert Debris landfills.
- s. Inert Debris processing facilities, recycling.
- t. Materials recovery facilities, new.
- u. Metal plating (prohibited within a 1,000-foot radius of a lot containing a sensitive use in Green Zone Districts).
- v. Polymer plastics and foam manufacture.
- w. scrap metal yards (outdoor operation). x. Smelting of tin, copper, zinc or iron ores.
- y. Solid waste landfills.
- z. Tannery or the curing or storage of raw hides.
- aa. Transfer stations.
- 4. Schedule for compliance. Existing structures or development for the uses subject to this Chapter shall comply with the applicable provisions of this Chapter, pursuant to <u>Section</u> <u>22.84.040</u> (Schedule for Compliance for Existing, Legally-Established Uses), below.
- 5. Exemption. Notwithstanding Subsection 1.a, above, this Chapter shall not apply to the
- a. Any existing, legally-established uses that have been operating with an approved discretionary land use permit as provided by this <u>Title 22</u>, until the expiration date of such permit or until a new discretionary permit is required.
- b. Any existing, legally-established automobile service station, for which a valid building permit has been issued prior to the effective date of this ordinance.

B. Exceptions.

f .\x-tb-CD CM220364-.dwg

1. When in conflict with other provisions of <u>Title 22</u>, the more restrictive requirements shall

2. Improvements made pursuant to this Chapter shall not be subject to <u>Chapter 22.172</u> (Nonconforming Uses, Buildings, and Structures).

(<u>Ord. 2022-0023</u>§ 25, 2022.)

22.84.030 - Standards and Requirements for Specific Uses.

- A. Application Requirements.
- 1. The following uses shall require a Conditional Use Permit (Chapter <u>22.158</u>) within a 500-foot radius of a lot containing a sensitive use in the Green Zone Districts as measured from any lot line.
- a. Industrial Uses.
- i. Assembly, manufacture, packaging, and storage of finished or prepared materials, including on-site manufacture of raw, natural, or synthesized flammable or toxic
- (a) Earthen products, including ceramics, sand, and stone, but excluding brick, terra cotta, and tile manufacture.
- (b) Precious and semi-precious metal products, including jewelry and lapidary.
- Assembly, manufacture, packaging, and storage of finished or prepared materials, provided that no manufacturing of raw natural or synthesized materials, including flammable or toxic chemicals, is conducted on-site. Metal products and parts; including the fabricating, engraving, spinning, storing, plating, and finishing of, where the use prohibits snap riveting and any process used in bending or shaping, which produces any audible nuisance or disagreeable noise, is prohibited. Use of perchloric acid is prohibited. Use excludes foundries and forging works.
 - iii. Food processing:
 - (a) Breweries.
 - (b) Dairy products depots.
 - (c) Slaughtering, dressing, processing, packing, and sale of poultry, fowl, rabbits, and other similar animals of comparable nature, form, and size.
 - (d) Starch mixing and bottling.
 - iv. Laundries and cleaning services, such as rug and carpet cleaning plants.
 - v. Manufacturing:
 - (a) Blacksmith shops.
 - (b) Boat building.
 - (c) Concrete batching plants, mixers of one cubic yard capacity or smaller.
 - (d) Engraving, machine metal engraving.
 - (e) Fabricating.
 - (f) Ice manufacturing, distribution, and storage.
 - (g) Lubricating oil canning and packaging, limited to 100 barrels stored aboveground
 - at a time.
 - (h) Lumberyard.
 - (i) Machine shops.
 - (j) Paint mixing, excluding lacquers and synthetic enamels.
 - (k) Presses, hydraulic presses for the molding of plastics.
 - (l) Refrigeration plants.
 - (m) Sand, the washing of sand to be used in sandblasting.
 - (n) Sheet metal shops.
 - (o) Stone, marble and granite; including grinding, dressing, and cutting.
 - vi. Recycling and Solid Waste uses, including auto dismantling/recycling (indoor
 - operation), and scrap metal (indoor operation).
 - vii. Storage:

Acetylene and oxygen storage in tanks. Oxygen shall be stored in a room separate from acetylene, and such rooms shall be separated by a not less than one-hour fire-resistant wall.

- (b) Boat storage.
- (c) Building materials.
- (d) Bus storage.
- (e) Car barns for buses and streetcars.
- (f) Cold storage plants.
- (g) Contractor's equipment yards, including farm and building trade equipment.
- (h) Distributing plants.
- (i) Draying yards or terminals.
- (j) Fuel yards.
- (k) Machinery storage yards.
- (l) Moving van storage or operating yards.
- (m) Plaster storage.
- (n) Produce yards and terminals.
- (o) Storage and rental of plows, tractors, buses, contractor's equipment, and cement
- (p) Truck and RV storage, including container storage.
- (q) Warehouses, including storage warehouses, which have a gross floor area of 100,000 square feet or greater.
- (r) Waste hauler vehicle or waste hauler container storage.
- (s) Wood yards.
- viii. Tire retreading or recapping
- ix. Valves, storage and repair of; including oil well valves.
- x. Welding.
- o. Vehicle-Related Uses:
- i. Automobile washing, automatic car wash.
- ii. Automobile washing, coin-operated, or hand wash.
- iii. Vehicle services, automobile body and fender repair, and paint shops. iv. Vehicle services, automobile impound, and tow yards.
- v. Vehicle services, automobile painting, and upholstering shops.
- vi. Vehicle services, any automobile repair garages that have accessory uses.

2. Projects that propose grading. Where grading is proposed for a project subject to a

c. New development, change of use, or major improvements proposed on a site that is

these uses, an environmental site assessment (Phase 1 Study) shall be submitted.

partially or entirely located within a half-mile radius of the boundaries of Superfund Sites,

as identified in the Environmental Protection Agency (EPA) National Priorities List. For

Vehicle services, new automobile service stations, including compressed natural gas filling stations.

viii. Vehicle services, automobile supply stores (outdoor only).

- Conditional Use Permit, such projects must comply with all federal, State, and local laws with regard to protection of Tribal Cultural Resources.
- 3. All other types of industrial or vehicle-related uses subject to this Chapter shall require a Ministerial Site Plan Review (Chapter <u>22.186</u>) or Minor Conditional Use Permit (Chapter <u>22.160</u>) application in compliance with this Section.
- 4. All uses subject to a Conditional Use Permit may be required to submit a noise evaluation report and control plans for odor, dust, and vibration prepared by a licensed professional at the request of Public Health. Mitigation measures, if required, shall be approved by Public Health prior to the permit being finalized.
- B. Additional Findings. When a Conditional Use Permit (Chapter 22.158) is required by this Section, or a Minor Conditional Use Permit (Chapter <u>22.160</u>) is required by <u>Title 22</u>, the following additional findings must be made in addition to the Conditional Use Permit findings required in Section 22.158.050.B (Findings and Decision) or Minor Conditional Use Permit findings in <u>Section</u> <u>22.160.050</u> (Findings and Decision):
- 1. The proposed use, development of land, and application of development standards are arranged to prevent adverse effects related to odor, noise, aesthetic, soil contamination, and air quality on neighboring property;
- 2. The proposed use and development of land employ appropriate environmental impact mitigation strategies, such as physical design characteristics, mechanical safeguards, or best practice strategies, including placement of construction equipment as far away from sensitive uses as possible, use of construction equipment that has properly operating and maintained mufflers, use of Zero Emissions construction equipment where feasible, orienting public address systems on-site away from nearby sensitive uses and setting system volume at a level not readily audible past the property line as feasible, and minimizes impacts on nearby sensitive uses; and
- 3. The proposed use and development of land protects public health and safety and promotes environmental sustainability.
- C. Development Standards.
- 1. Development Standards for All Uses Subject to this Chapter
- a. Solid walls.
- i. The following uses shall provide solid walls along the street frontage and any other lot lines adjoining a lot containing sensitive uses:
- (a) Boat storage.
- (b) Bus storage.
- (c) Organic waste facilities.
- (d) Pallet yards.
- (e) Recycling collection facilities.
- (f) Recycling processing facilities.
- (g) Truck and RV storage. (h) Uses that have accessory uses or secondary, related activities other than parking occurring outdoors.
- ii. Required solid walls shall meet the following standards:
- (a) Be of a uniform height between eight and 12 feet;

masonry unit ("CMU") or masonry, brick, etc.

- (b) Be of a minimum thickness of six inches;
- (c) Be a neutral color; and (d) Be constructed in workmanlike manner and consist of materials such as concrete
- iii. Any type of fencing or wire is prohibited, except that metal gates may be permitted for the purpose of vehicular access.
- b. Landscaping on street frontage. Required solid walls along street frontages shall be set back by landscaping of a minimum of five feet in depth, as described below, unless the landscaping encroaches into the required existing parking spaces and associated maneuvering areas, or existing building or structures. The landscaping shall be verified on a landscaping plan submitted to the Department and consist of the following:
- i. One 15-gallon tree for every 100 square feet of landscaped area shall be planted and spaced 10 feet apart. The remaining area shall also be landscaped with grass, shrubs, or bushes, etc. All plants provided for required landscaping shall be drought-tolerant and include only non-invasive plant species.
- ii. The landscaping shall be maintained in a healthy condition with appropriate watering, pruning, weeding, fertilizing, and litter removal. Trees shall be planted in locations that maintain the required lines of sight for safe pedestrian and vehicular movement and shall not cause root damage to the sidewalk or other public infrastructure, to the satisfaction of Public Works
- iii. Trees planted near buildings or fire lanes shall be placed in locations that do not adversely impact the Fire Department operations or response times, to the satisfaction of the Fire Department.
- iv. Trees shall be selected from the Tree Species List maintained by the Director.
- v. Landscaping equipment used for maintenance, such as lawn mowers and leaf blowers, shall be electric and non-combustion powered.
- vi. Notwithstanding Chapter 12.84 (Low Impact Development Standards) of the County Code, parcels subject to this <u>Chapter 22.84</u> (Green Zone Districts) and less than one acre in size shall not be exempt from Low Impact Development requirements.
- c. Storage of Materials, Vehicles, or Equipment.
- i. Any materials, vehicles, or equipment that are stored outdoors shall not exceed the height of the surrounding wall, shall be fully contained within the property boundaries, and shall not spill over onto public rights-of-way.
- i. Stored materials shall be set back at least 10 feet from the wall or the length equal to the wall height, whichever is greater.
- iii. The area between the stored materials and the wall may be landscaped.
- d. Enclosures.

d. Enclosures.

- i. Any area used for storage or handling of hazardous materials, including above-ground storage tanks, shall be within an enclosure and fully screened from the public right-of-
- ii. A completely enclosed building shall be provided for the following, unless another regulatory agency requires natural ventilation as part of the regulatory code:
- (a) Any area where manufacturing or repair work occurs, such as assembly or disassembly of parts, repairs, processing of materials, or operation of equipment that emits or generates dust, smoke, gas, fumes, cinder, or waste; or
- (b) Recycling processing facilities, including auto dismantling activity, and scrap metal crushing and shredding.
- (1) Auto dismantling activity, and scrap metal crushing and shredding, shall be placed furthest away from nearby sensitive uses as possible and be fully enclosed within a building.
- (2) The garage door or opening of the enclosed building for auto dismantling activity, and scrap metal crushing and shredding, shall face the opposite direction of the nearest sensitive use and may be kept open during operation for ventilation.

Ancillary operations, storage, and parking, aside from auto dismantling activity, and scrap metal crushing and shredding, may be conducted outdoors, provided that it is fully contained within the property boundaries and no storage or operation occurs on adjacent public rights-of-way or neighboring properties.

- e. Surfacing. Areas designated for vehicle parking, vehicle circulation, or storage of materials or equipment shall be paved with impervious materials such as an asphalt or an oil and aggregate mixture, use light color pavement, and be maintained to the satisfaction of the Director. Paved areas shall be clustered to maximize pervious area. Alternative paving materials may be permitted to the satisfaction of the Director and Public Works.
- i. All areas of broken concrete or asphalt, including, but not limited to, divots, cracks, potholes, and spalling of concrete or asphalt in the raw material receiving area of a recycling processing facility, or any portion of the facility where waste materials are unloaded and touch the ground outside of an enclosure, shall be patched, repaired, or repaved as necessary to prevent standing water or puddles with a surface area greater than one square foot from accumulating.
- and solid waste shall meet the requirements set forth in <u>Chapter 22.132</u> (Storage Enclosure Requirements for Recycling and Solid Waste). g. Vehicular access and on-site circulation for cars and trucks. For new uses, driveway entrances and exits shall be located as far away from sensitive uses as feasible, and onsite vehicular circulation and truck loading and unloading areas, including truck loading

f. Recycling and Solid Waste Storage. Any trash receptacles or storage areas for recycling

- docks, shall be located in the rear or on the side of structures, or as far away from the nearest sensitive use as feasible, to the satisfaction of the Director. Queuing and check-in points for trucks must be located on-site and furthest away from any property lines that are closest to any nearby sensitive use, when feasible. In cases of infeasibility for uses subject to a Conditional Use Permit, an additional finding must be made to justify why this may not be possible.
- include at least one sign stating that vehicle idling shall be limited to five minutes. Graphics related to the vehicle idle limitation are permitted on said sign. Said sign shall be a minimum size of 12 inches wide by 18 inches in height and shall be prominently displayed and visible from the loading spaces/area. Said sign may contain language such as "5-minute idle limit," "spare the air," "please turn off engine when stopped," or similar

h. "No Idling" Sign Required. Where loading spaces are provided, the loading area shall

i. Accessory Structures and Utilities. A site that contains an outdoor operation with an office shall permanently affix the building to the ground and provide one toilet that is served by public water and sewer, or otherwise approved by the Director, as well as by Public Health

- and Public Works. j. Perimeter Identification Signs. In addition to the signs permitted by <u>Chapter 22.114</u> (Signs), and notwithstanding any contrary provisions in Division 10 (Community Standards Districts) in <u>Title 22</u>, each facility or site shall provide a perimeter identification sign that
 - complies with the following: i. A perimeter identification sign shall be permanently affixed on a building or wall that is visible, and with text that is legible from the public right-of-way for pedestrians, and no higher than eight feet from the ground measured vertically from the base of the sign. Freestanding signs or portable signs are prohibited as a perimeter identification
 - ii. A perimeter identification sign shall have a minimum sign area of four square feet and a maximum of nine square feet. The area for a perimeter identification sign shall not be accounted for in the area permitted for business signs specified in <u>Chapter 22.114</u>
 - iii. The perimeter identification sign shall permanently display hours of operation, telephone number of the facility representative, and emergency contact information for reporting any problems which may occur related to the operation of the facility 24 hours a day, seven days a week. The sign shall also include the business name unless the property also contains a separate business sign that is clearly visible from the public right-of-way. The sign shall also include instructions for reporting violations to the Department and Air Quality Management District (AQMD), where a use is also regulated by AQMD. Information for reporting violations shall include the following text, or as updated by the Department or South Coast Air Quality Management District
 - (a) "To report a violation to the Los Angeles County Department of Regional Planning, call 213-974-6453 Monday—Thursday, 7 a.m. - 6 p.m., dial 2-1-1 at any time or email zoningenforcement@planning.lacounty.gov;" and
 - (b) "To report a violation to South Coast Air Quality Management District (SCAQMD), call 1-800-CUTSMOG or visit www.aqmd.gov."

iv. Multi-tenant buildings or sites may provide one such sign containing the information

for all tenants listed in Subsection C.1.iii, above, provided that each tenant has its own

business identification sign that is clearly visible from the public right-of-way. k. Hazardous sites. Any proposed project on a parcel known to be a hazardous property or listed on the Cortese List maintained by the California EPA shall provide appropriate


federal, State, or local agency clearance letter for the site. In addition, any parcel known to

CM220364 JOB NO. SUBMITTAL DATE CITY SUBMITTAL 10/25/23 REVISION DATE

LADBS STAMP

Rextord Industrial

RIAL

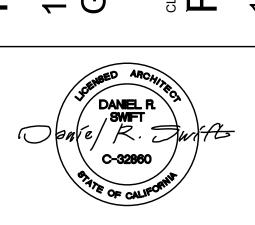



STANDARDS

February 06, 2024 SUBMITTAL SET

G001

02/06/2024

22.84.010 - Purpose.

The Green Zone Districts are established to promote environmental justice in communities that are disproportionately affected by toxic pollutants and contaminants generated from various land uses over time. This Chapter provides regulations and procedures for new and existing land uses to ensure that such land uses will be operated in consideration of the surrounding sensitive uses as defined in Chapter 22.14 (Definitions), minimizing potential adverse health and safety impacts, and promoting clean industrial uses. The Green Zone Districts are identified as the unincorporated communities of Avocado Heights, East Los Angeles, East Rancho Dominguez, Florence-Firestone, South San Jose Hills, West Whittier-Los Nietos, Walnut Park, West Athens-Westmont, Willowbrook, West Carson, and West Rancho Dominguez-Victoria.

(<u>Ord. 2022-0023</u>§ 25, 2022.)

22.84.020 - Applicability.

- A. General Applicability. This Chapter applies to uses that are located in permitted zones within the Green Zone Districts, as depicted on Figure 22.84.050-A, and meet all criteria described below:
- 1. Types of uses.
 - a. New and existing, legally-established uses listed under the Industrial Uses category, except for the airport-related sub-category, in Table 22.22.030-B (Principal Use Regulations for Industrial Zones), including airports, heliports, helistops, and landing
 - b. New and existing, legally-established uses listed under Recycling and Solid Waste Uses category in Table 22.22.030-B (Principal Use Regulations for Industrial Zones).
 - c. New and existing, legally-established uses listed under the Vehicle-Related Uses, in Table 22.22.030-B (Principal Use Regulations for Industrial Zones), except for the vehicle sales and rentals sub-category. Supply stores under the vehicle services sub-category that are within fully enclosed buildings are also not subject to this Chapter.
 - d. New automobile service stations and new drive-through establishments as defined in <u>Chapter 22.14</u> (Definitions), listed in Table 22.20.030-B (Principal Use Regulations for Commercial Zones).

2. Location of uses.

- a. Any lots, or portion thereof, that contain the uses described in Subsections 1.a, 1.b, 1.c, or 1.d, above, and are located within a 500-foot radius of a lot that contains a sensitive use as defined in Chapter 22.14 (Definitions) as of the effective date of this ordinance, shall comply with the requirments in sections 22.84.030, 22.84.040, and 22.84.050, below.
- b. For the purpose of this Chapter, all requirements shall also apply to such lots, or portions thereof, if the sensitive use within a 500-foot radius is located within an incorporated area and is also a residential use.
- 3. Prohibited uses. The following uses are prohibited within a 500-foot radius of a lot containing
- a sensitive use in Green Zone Districts, except where noted:
- a. Acid manufacture.
- b. Anaerobic digestion facility, except as an accessory to a legally-established use that processes waste generated on-site only.
- c. Auto dismantling (outdoor operation).
- d. Cement, lime, gypsum, or plaster of Paris manufacture.
- e. Chipping and grinding.
- f. Combustion or non-combustion biomass conversion facility, except for a non-combustion biomass conversion facility that processes waste generated on-site only.
- g. Composting facility, except for green waste composting only.
- h. Compressed natural gas manufacture.
- i. Construction and demolition facility, recycling.
- j. Conversion technology facility, recycling, or solid waste.
- k. Distillation of bones.
- Drop hammers.
- m. Explosives.
- n. Forging works.
- o. Fertilizer manufacture, except accessory composting of on-site generated waste associated with a legally-established commercial or agricultural use.
- p. Gas manufacture, except accessory anaerobic digestion of on-site generated waste associated with a legally-established commercial or agricultural use.
- q. Glue manufacture.
- r. Inert Debris landfills.
- s. Inert Debris processing facilities, recycling.
- t. Materials recovery facilities, new.
- u. Metal plating (prohibited within a 1,000-foot radius of a lot containing a sensitive use in Green Zone Districts).
- v. Polymer plastics and foam manufacture.
- w. scrap metal yards (outdoor operation). x. Smelting of tin, copper, zinc or iron ores.
- y. Solid waste landfills.
- z. Tannery or the curing or storage of raw hides.
- aa. Transfer stations.
- 4. Schedule for compliance. Existing structures or development for the uses subject to this Chapter shall comply with the applicable provisions of this Chapter, pursuant to <u>Section</u> <u>22.84.040</u> (Schedule for Compliance for Existing, Legally-Established Uses), below.
- 5. Exemption. Notwithstanding Subsection 1.a, above, this Chapter shall not apply to the
- a. Any existing, legally-established uses that have been operating with an approved discretionary land use permit as provided by this <u>Title 22</u>, until the expiration date of such permit or until a new discretionary permit is required.
- b. Any existing, legally-established automobile service station, for which a valid building permit has been issued prior to the effective date of this ordinance.

B. Exceptions.

1. When in conflict with other provisions of <u>Title 22</u>, the more restrictive requirements shall apply.

2. Improvements made pursuant to this Chapter shall not be subject to <u>Chapter 22.172</u> (Nonconforming Uses, Buildings, and Structures).

(<u>Ord. 2022-0023</u>§ 25, 2022.)

22.84.030 - Standards and Requirements for Specific Uses.

- A. Application Requirements.
- 1. The following uses shall require a Conditional Use Permit (Chapter <u>22.158</u>) within a 500-foot radius of a lot containing a sensitive use in the Green Zone Districts as measured from any lot line.
- a. Industrial Uses.
- i. Assembly, manufacture, packaging, and storage of finished or prepared materials, including on-site manufacture of raw, natural, or synthesized flammable or toxic
- (a) Earthen products, including ceramics, sand, and stone, but excluding brick, terra cotta, and tile manufacture.
- (b) Precious and semi-precious metal products, including jewelry and lapidary.
- Assembly, manufacture, packaging, and storage of finished or prepared materials, provided that no manufacturing of raw natural or synthesized materials, including flammable or toxic chemicals, is conducted on-site. Metal products and parts; including the fabricating, engraving, spinning, storing, plating, and finishing of, where the use prohibits snap riveting and any process used in bending or shaping, which produces any audible nuisance or disagreeable noise, is prohibited. Use of perchloric acid is prohibited. Use excludes foundries and forging works.
 - iii. Food processing:
 - (a) Breweries.
 - (b) Dairy products depots.
 - (c) Slaughtering, dressing, processing, packing, and sale of poultry, fowl, rabbits, and other similar animals of comparable nature, form, and size.
 - (d) Starch mixing and bottling.
 - iv. Laundries and cleaning services, such as rug and carpet cleaning plants.
 - v. Manufacturing:
 - (a) Blacksmith shops.
 - (b) Boat building.
 - (c) Concrete batching plants, mixers of one cubic yard capacity or smaller.
 - (d) Engraving, machine metal engraving.
 - (e) Fabricating.
 - (f) Ice manufacturing, distribution, and storage.
 - (g) Lubricating oil canning and packaging, limited to 100 barrels stored aboveground
 - at a time.
 - (h) Lumberyard.
 - (i) Machine shops.
 - (j) Paint mixing, excluding lacquers and synthetic enamels.
 - (k) Presses, hydraulic presses for the molding of plastics.
 - (l) Refrigeration plants.
 - (m) Sand, the washing of sand to be used in sandblasting.
 - (n) Sheet metal shops.
 - (o) Stone, marble and granite; including grinding, dressing, and cutting.
 - vi. Recycling and Solid Waste uses, including auto dismantling/recycling (indoor operation), and scrap metal (indoor operation).
 - vii. Storage:

Acetylene and oxygen storage in tanks. Oxygen shall be stored in a room separate from acetylene, and such rooms shall be separated by a not less than one-hour fire-resistant wall.

- (b) Boat storage.
- (c) Building materials.
- (d) Bus storage.
- (e) Car barns for buses and streetcars.
- (f) Cold storage plants.
- (g) Contractor's equipment yards, including farm and building trade equipment.
- (h) Distributing plants.
- (i) Draying yards or terminals.
- (j) Fuel yards.
- (k) Machinery storage yards.
- (l) Moving van storage or operating yards.
- (m) Plaster storage.
- (n) Produce yards and terminals.
- (o) Storage and rental of plows, tractors, buses, contractor's equipment, and cement
- (p) Truck and RV storage, including container storage.
- (q) Warehouses, including storage warehouses, which have a gross floor area of 100,000 square feet or greater.
- (r) Waste hauler vehicle or waste hauler container storage.
- (s) Wood yards.
- viii. Tire retreading or recapping
- ix. Valves, storage and repair of; including oil well valves.
- x. Welding.
- b. Vehicle-Related Uses:
- i. Automobile washing, automatic car wash.
- ii. Automobile washing, coin-operated, or hand wash.
- iii. Vehicle services, automobile body and fender repair, and paint shops. iv. Vehicle services, automobile impound, and tow yards.
- v. Vehicle services, automobile painting, and upholstering shops.
- vi. Vehicle services, any automobile repair garages that have accessory uses.

Vehicle services, new automobile service stations, including compressed natural gas filling stations. viii. Vehicle services, automobile supply stores (outdoor only).

- c. New development, change of use, or major improvements proposed on a site that is partially or entirely located within a half-mile radius of the boundaries of Superfund Sites, as identified in the Environmental Protection Agency (EPA) National Priorities List. For these uses, an environmental site assessment (Phase 1 Study) shall be submitted.
- 2. Projects that propose grading. Where grading is proposed for a project subject to a Conditional Use Permit, such projects must comply with all federal, State, and local laws with regard to protection of Tribal Cultural Resources.
- 3. All other types of industrial or vehicle-related uses subject to this Chapter shall require a Ministerial Site Plan Review (Chapter <u>22.186</u>) or Minor Conditional Use Permit (Chapter <u>22.160</u>) application in compliance with this Section.
- 4. All uses subject to a Conditional Use Permit may be required to submit a noise evaluation report and control plans for odor, dust, and vibration prepared by a licensed professional at the request of Public Health. Mitigation measures, if required, shall be approved by Public Health prior to the permit being finalized.
- B. Additional Findings. When a Conditional Use Permit (Chapter 22.158) is required by this Section, or a Minor Conditional Use Permit (Chapter <u>22.160</u>) is required by <u>Title 22</u>, the following additional findings must be made in addition to the Conditional Use Permit findings required in Section 22.158.050.B (Findings and Decision) or Minor Conditional Use Permit findings in <u>Section</u> <u>22.160.050</u> (Findings and Decision):
- 1. The proposed use, development of land, and application of development standards are arranged to prevent adverse effects related to odor, noise, aesthetic, soil contamination, and air quality on neighboring property;
- 2. The proposed use and development of land employ appropriate environmental impact mitigation strategies, such as physical design characteristics, mechanical safeguards, or best practice strategies, including placement of construction equipment as far away from sensitive uses as possible, use of construction equipment that has properly operating and maintained mufflers, use of Zero Emissions construction equipment where feasible, orienting public address systems on-site away from nearby sensitive uses and setting system volume at a level not readily audible past the property line as feasible, and minimizes impacts on nearby sensitive uses; and
- 3. The proposed use and development of land protects public health and safety and promotes environmental sustainability.
- C. Development Standards.
- 1. Development Standards for All Uses Subject to this Chapter
- a. Solid walls.
- i. The following uses shall provide solid walls along the street frontage and any other lot lines adjoining a lot containing sensitive uses:
- (a) Boat storage.
- (b) Bus storage.
- (c) Organic waste facilities.
- (d) Pallet yards. (e) Recycling collection facilities.
- (f) Recycling processing facilities.
- (g) Truck and RV storage.
- (h) Uses that have accessory uses or secondary, related activities other than parking occurring outdoors.
- ii. Required solid walls shall meet the following standards:
- (a) Be of a uniform height between eight and 12 feet;
- (b) Be of a minimum thickness of six inches;

(c) Be a neutral color; and

(d) Be constructed in workmanlike manner and consist of materials such as concrete masonry unit ("CMU") or masonry, brick, etc.

iii. Any type of fencing or wire is prohibited, except that metal gates may be permitted for

- the purpose of vehicular access. b. Landscaping on street frontage. Required solid walls along street frontages shall be set back by landscaping of a minimum of five feet in depth, as described below, unless the
- a landscaping plan submitted to the Department and consist of the following: i. One 15-gallon tree for every 100 square feet of landscaped area shall be planted and spaced 10 feet apart. The remaining area shall also be landscaped with grass, shrubs, or bushes, etc. All plants provided for required landscaping shall be drought-tolerant

maneuvering areas, or existing building or structures. The landscaping shall be verified on

landscaping encroaches into the required existing parking spaces and associated

- and include only non-invasive plant species. ii. The landscaping shall be maintained in a healthy condition with appropriate watering, pruning, weeding, fertilizing, and litter removal. Trees shall be planted in locations that maintain the required lines of sight for safe pedestrian and vehicular movement and shall not cause root damage to the sidewalk or other public infrastructure, to the satisfaction of Public Works
- iii. Trees planted near buildings or fire lanes shall be placed in locations that do not adversely impact the Fire Department operations or response times, to the satisfaction of the Fire Department.
- iv. Trees shall be selected from the Tree Species List maintained by the Director.
- v. Landscaping equipment used for maintenance, such as lawn mowers and leaf blowers, shall be electric and non-combustion powered.
- vi. Notwithstanding Chapter 12.84 (Low Impact Development Standards) of the County Code, parcels subject to this <u>Chapter 22.84</u> (Green Zone Districts) and less than one acre in size shall not be exempt from Low Impact Development requirements.
- c. Storage of Materials, Vehicles, or Equipment.
- i. Any materials, vehicles, or equipment that are stored outdoors shall not exceed the height of the surrounding wall, shall be fully contained within the property boundaries, and shall not spill over onto public rights-of-way.
- ii. Stored materials shall be set back at least 10 feet from the wall or the length equal to the wall height, whichever is greater.
- iii. The area between the stored materials and the wall may be landscaped.
- d. Enclosures.

d. Enclosures.

- i. Any area used for storage or handling of hazardous materials, including above-ground storage tanks, shall be within an enclosure and fully screened from the public right-of-
- ii. A completely enclosed building shall be provided for the following, unless another regulatory agency requires natural ventilation as part of the regulatory code:
- (a) Any area where manufacturing or repair work occurs, such as assembly or disassembly of parts, repairs, processing of materials, or operation of equipment that emits or generates dust, smoke, gas, fumes, cinder, or waste; or
- (b) Recycling processing facilities, including auto dismantling activity, and scrap metal crushing and shredding.
- (1) Auto dismantling activity, and scrap metal crushing and shredding, shall be placed furthest away from nearby sensitive uses as possible and be fully enclosed within a building.
- (2) The garage door or opening of the enclosed building for auto dismantling activity, and scrap metal crushing and shredding, shall face the opposite direction of the nearest sensitive use and may be kept open during operation for ventilation.

Ancillary operations, storage, and parking, aside from auto dismantling activity, and scrap metal crushing and shredding, may be conducted outdoors, provided that it is fully contained within the property boundaries and no storage or operation occurs on adjacent public rights-of-way or neighboring properties.

- e. Surfacing. Areas designated for vehicle parking, vehicle circulation, or storage of materials or equipment shall be paved with impervious materials such as an asphalt or an oil and aggregate mixture, use light color pavement, and be maintained to the satisfaction of the Director. Paved areas shall be clustered to maximize pervious area. Alternative paving materials may be permitted to the satisfaction of the Director and Public Works.
- i. All areas of broken concrete or asphalt, including, but not limited to, divots, cracks, potholes, and spalling of concrete or asphalt in the raw material receiving area of a recycling processing facility, or any portion of the facility where waste materials are unloaded and touch the ground outside of an enclosure, shall be patched, repaired, or repaved as necessary to prevent standing water or puddles with a surface area greater than one square foot from accumulating.
- f. Recycling and Solid Waste Storage. Any trash receptacles or storage areas for recycling and solid waste shall meet the requirements set forth in <u>Chapter 22.132</u> (Storage Enclosure Requirements for Recycling and Solid Waste).

g. Vehicular access and on-site circulation for cars and trucks. For new uses, driveway

- entrances and exits shall be located as far away from sensitive uses as feasible, and onsite vehicular circulation and truck loading and unloading areas, including truck loading docks, shall be located in the rear or on the side of structures, or as far away from the nearest sensitive use as feasible, to the satisfaction of the Director. Queuing and check-in points for trucks must be located on-site and furthest away from any property lines that are closest to any nearby sensitive use, when feasible. In cases of infeasibility for uses subject to a Conditional Use Permit, an additional finding must be made to justify why this
- h. "No Idling" Sign Required. Where loading spaces are provided, the loading area shall include at least one sign stating that vehicle idling shall be limited to five minutes. Graphics related to the vehicle idle limitation are permitted on said sign. Said sign shall be a minimum size of 12 inches wide by 18 inches in height and shall be prominently displayed and visible from the loading spaces/area. Said sign may contain language such as "5-minute idle limit," "spare the air," "please turn off engine when stopped," or similar

i. Accessory Structures and Utilities. A site that contains an outdoor operation with an office

shall permanently affix the building to the ground and provide one toilet that is served by

public water and sewer, or otherwise approved by the Director, as well as by Public Health

may not be possible.

- and Public Works. j. Perimeter Identification Signs. In addition to the signs permitted by <u>Chapter 22.114</u> (Signs), and notwithstanding any contrary provisions in Division 10 (Community Standards Districts) in <u>Title 22</u>, each facility or site shall provide a perimeter identification sign that
 - complies with the following: i. A perimeter identification sign shall be permanently affixed on a building or wall that is visible, and with text that is legible from the public right-of-way for pedestrians, and no higher than eight feet from the ground measured vertically from the base of the sign. Freestanding signs or portable signs are prohibited as a perimeter identification
 - ii. A perimeter identification sign shall have a minimum sign area of four square feet and a maximum of nine square feet. The area for a perimeter identification sign shall not be accounted for in the area permitted for business signs specified in <u>Chapter 22.114</u>
 - iii. The perimeter identification sign shall permanently display hours of operation, telephone number of the facility representative, and emergency contact information for reporting any problems which may occur related to the operation of the facility 24 hours a day, seven days a week. The sign shall also include the business name unless the property also contains a separate business sign that is clearly visible from the public right-of-way. The sign shall also include instructions for reporting violations to the Department and Air Quality Management District (AQMD), where a use is also regulated by AQMD. Information for reporting violations shall include the following text, or as updated by the Department or South Coast Air Quality Management District
 - (a) "To report a violation to the Los Angeles County Department of Regional Planning, call 213-974-6453 Monday—Thursday, 7 a.m. - 6 p.m., dial 2-1-1 at any time or email zoningenforcement@planning.lacounty.gov;" and
 - (b) "To report a violation to South Coast Air Quality Management District (SCAQMD), call 1-800-CUTSMOG or visit www.aqmd.gov."

iv. Multi-tenant buildings or sites may provide one such sign containing the information

- for all tenants listed in Subsection C.1.iii, above, provided that each tenant has its own business identification sign that is clearly visible from the public right-of-way. k. Hazardous sites. Any proposed project on a parcel known to be a hazardous property or
- listed on the Cortese List maintained by the California EPA shall provide appropriate federal, State, or local agency clearance letter for the site. In addition, any parcel known to

SUBMITTAL DATE CITY SUBMITTAL 10/25/23 REVISION DATE

JOB NO.


LADBS STAMP

CM220364



Industrial

RIAL

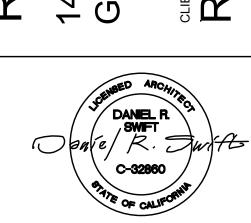



GREEN ZONE DEVELOPMENT STANDARDS

SHEET NO.

02/06/2024

SUBMITTAL SET

G001 February 06, 2024

have a previous use that potentially generated hazardous materials shall demonstrate that the site is clear of contamination with a Phase 1 study.

- 2. New Development or Proposed Expansions to Existing, Legally-Established Uses Adjacent to Sensitive Uses.
- a. Building setback. A minimum of a 10-foot setback shall be provided along the property lines adjacent to sensitive uses. Any proposed additions above the ground floor of existing, legally-established uses adjacent to sensitive uses shall also be set back 10 feet from the nearest property line.
- b. Building height. Any new building or structures, or any portion proposed for additions, excluding chimneys, rooftop antennas, roof-mounted solar panels, or other rooftop equipment including HVAC units, air purifiers, etc., shall set back the portion of the building or structure one additional foot for every foot above 35 feet in height, up to a maximum height of 45 feet.
- 3. Standards for Specific Uses. In addition to Subsection C.1 and C.2, above, the following standards shall apply to the uses listed below on the effective date of this ordinance, unless otherwise specified.
- a. Automobile and vehicle repair shops. No open vehicle hood is permitted outside of the
- b. New automobile service stations, including compressed natural gas filling stations:i. Are exempt from Subsection C.1, above.
- ii. Shall locate the gasoline or fuel dispensing areas at least 50 feet from the nearest sensitive uses.
- c. Warehouses. The following standards apply to new warehouses. The following standards, except for Subsection vi, below, apply to existing warehouses, and shall be met within five years of the effective date of this ordinance.
- i. Utilize electric or alternatively fueled sweepers with HEPA filters.
- ii. Utilize Energy Star heating, cooling, and lighting devices, and appliances.
- iii. Off-road equipment. All off-road equipment (non-street legal), such as forklifts and other machinery, used on-site for warehouse operations shall be powered by alternative fuels, electrical batteries, or other alternative/non-diesel fuels (e.g., propane) that do not emit diesel particulate matter, and that are zero or low-emission.
- iv. Landscaping equipment. All landscaping equipment, such as lawn mowers and leaf blowers used on-site shall be electrically powered.
- v. Zero-emission or near-zero emission trucks. Warehouses with a minimum gross floor area of 100,000 square feet shall comply with AQMD Rule 2305 or current standards.
- vi. New warehouses shall have a minimum 100-foot buffer consisting of office space, employee parking, and/or landscaping between primary operation and lot lines that are closest to nearby sensitive uses.
- d. New drive-through establishments. The following standards shall apply to new drive-through establishments only:
- i. Compliance with the requirements set forth in Subsection C.2.a, above.
- ii. A maintenance plan shall be submitted as part of the Conditional Use Permit application, to the satisfaction of the Director, and the drive-through establishment shall comply with the maintenance plan.
- iii. The location of the drive-through area, including cashier microphone, speakers, and drive-through lane, shall be located at least 20 feet from the property line of any adjoining residentially-zoned lot, and speakers and lighted menus shall be oriented away from such lots.
- iv. Hours of operation for the drive-through area shall be no earlier than 6:00 a.m. and no later than 12:00 a.m.
- A buffer, which may include a six-foot solid wall, as depicted on the site plan, shall be provided to reduce noise trespass from the drive-through area to any adjoining residentially-zoned lot.
- vi. The required trash bin shall be enclosed by a decorative wall measuring at least five feet tall, but not more than six feet tall, and shall have solid doors.

D. Modification.

- A modification may be requested through a Minor Conditional Use Permit (Chapter 22.160)
 application if the use is subject to a Minor Conditional Use Permit or Site Plan Review
 (Chapter 22.186), or through a Conditional Use Permit (Chapter 22.158) application if the use
 requires a Conditional Use Permit, for the development standards listed below:
- a. Solid walls (Subsection C.1.a.ii).
- b. Landscaping (Subsection C.1.b.i).
- c. Accessory Structures and Utilities (Subsection C.1.i).
- d. Signs (Subsection C.1.j.ii).
- e. Warehouses (Subsections C.3.c.iii, iv, v, and vi).
- 2. When a modification is requested for any development standards listed in Subsection D.1, above, the following findings must be made in addition to the findings required in Subsection B (Additional Findings), above:

а.

Due to topographic or physical features of the site, strict compliance with all the required development standards would substantially and unreasonably interfere with the establishment of the proposed project or continuation of the existing operation on the subject property; and

- b. The requested modification provides alternative means to prevent adverse effects on environment and public health of the community.
- E. Performance Standards for All Uses.
- 1. Hours of outdoor operation. No outdoor operation or activities shall be conducted between 6:00 p.m. and 8:00 a.m., daily, with the exception of truck loading and unloading into an enclosed building only.
- 2. Storage of Materials and Waste. All materials or waste shall be stored in designated receptacles, bins, or pallets, and located on a paved impermeable surface on site, or within an enclosed building.
- 3. Site Maintenance. Other than for the collection or receipt of items related to the principal use, exterior areas of the premises shall be maintained free of garbage, trash, debris, or junk and salvage except as stored in designated trash collection containers and enclosures.
- F. Fees. When a Conditional Use Permit (Chapter <u>22.158</u>) is required, fees may be assessed to offset the costs associated with the project mitigation, enforcement activities, operational impact mitigation studies, community benefit programs, and other costs related to the Project's impacts

on the surrounding communities.

(Ord. 2022-0023 § 25, 2022.)

22.84.040 - Schedule for Compliance for Existing, Legally-Established Uses.

A. Existing, legally-established uses that are subject to this Chapter shall be brought into compliance with all applicable requirements of this Chapter according to the schedule identified in Table 22.84.040-A, below, as follows, provided that the number of years to comply is accounted from the effective date of this ordinance:

TABLE 22.84.040-A: SCHEDULE FOR COMPLIANCE FOR EXISTING, LEGALLY-ESTABLISHED USES UP TO 500 FEET FROM A SENSITIVE USE ¹					
Permit Required	3 Years	5 Years	7 Years		

Due to topographic or physical features of the site, strict compliance with all the required development standards would substantially and unreasonably interfere with the establishment of the proposed project or continuation of the existing operation on the subject property; and

- b. The requested modification provides alternative means to prevent adverse effects on environment and public health of the community.
- E. Performance Standards for All Uses.
- 1. Hours of outdoor operation. No outdoor operation or activities shall be conducted between 6:00 p.m. and 8:00 a.m., daily, with the exception of truck loading and unloading into an enclosed building only.
- 2. Storage of Materials and Waste. All materials or waste shall be stored in designated receptacles, bins, or pallets, and located on a paved impermeable surface on site, or within an enclosed building.
- 3. Site Maintenance. Other than for the collection or receipt of items related to the principal use, exterior areas of the premises shall be maintained free of garbage, trash, debris, or junk and salvage except as stored in designated trash collection containers and enclosures.
- F. Fees. When a Conditional Use Permit (Chapter 22.158) is required, fees may be assessed to offset the costs associated with the project mitigation, enforcement activities, operational impact mitigation studies, community benefit programs, and other costs related to the Project's impacts on the surrounding communities.

(Ord. 2022-0023 § 25, 2022.)

Notes:

22.84.040 - Schedule for Compliance for Existing, Legally-Established Uses.

A. Existing, legally-established uses that are subject to this Chapter shall be brought into compliance with all applicable requirements of this Chapter according to the schedule identified in Table 22.84.040-A, below, as follows, provided that the number of years to comply is accounted from the effective date of this ordinance:

TABLE 22.84.040-A: SCHEDULE FOR COMPLIANCE FOR EXISTING, LEGALLY-ESTABLISHED USES UP TO 500 FEET FROM A SENSITIVE USE 1 3 Years 5 Years 7 Years Permit Required Installation of any Installation of walls, Installation of SPR for uses up to 100 feet from a one or both of the surfacing, or specific | building enclosure following combined standards for Sensitive Use and any other and no other improvements for warehouses, along with or without any | SPR improvements:

	signage, landscaping	other improvements combined, if new building enclosure is not required	
SPR for uses between 101—500 feet from a Sensitive Use	N/A	Installation of any one or all improvements, including specific standards for warehouses, if new building enclosure is not required	Installation of building enclosure and any other improvements for SPR
CUP or MCUP for uses up to 100 feet from a Sensitive Use	N/A	CUP or MCUP attainment and installation of any one or all improvements, if new building enclosure is not required; specific standards for warehouses.	Installation of building enclosure and any other improvements for CUPs or MCUPs
CUP or MCUP for uses between 101— 500 feet from a Sensitive Use	N/A	N/A	CUP or MCUP attainment and installation of all improvements

1. Section 24.84.030.E (Performance Standards for all Uses), shall apply to existing, legally-established uses at the time of the compliance schedule deadline for the established use.

- 1. Existing uses that are entirely or partially within a 100-foot radius of a lot containing a sensitive use in a permitted zone and:
- a. Subject to a Ministerial Site Plan (Chapter 22.186), pursuant to this Chapter for the requirements specified in Subsection C.1.b (Landscaping) or C.1.j (Perimeter Identification Signs) of Section 22.84.030, only and no other improvements required, three years;
- b. Subject to a Ministerial Site Plan (Chapter 22.186), pursuant to this Chapter for any one or combination of the requirements specified in Subsections C.1.a through C.1.j of Section 22.84.030, except Subsection C.1.b (Landscaping) or C.1.j (Perimeter Identification Signs) alone or in combination, and except for Subsection C.1.d (Building Enclosure), five years;
 c. Subject to a Ministerial Site Plan (Chapter 22.186), pursuant to this Chapter for the requirements specified in Subsection C.3.c (Standards for Specific Uses, Warehouses) of Section 22.84.030, five years;
- d. Subject to a Ministerial Site Plan (Chapter 22.186), pursuant to this Chapter for the requirements specified in Subsection C.1.d (Building Enclosure) only, or Subsection C.1.d along with any other requirements of Section 22.84.030, seven years;
- e. Subject to a Conditional Use Permit (Chapter 22.158), pursuant to this Chapter for the requirements specified in Subsections C.1.a (Solid walls), C.1.b (Landscaping on street frontage), C.1.j (Perimeter Identification Signs), or C.3.c (Standards for Specific Uses, Warehouses) only, of Section 22.84.030, five years; or
- f. Subject to a Conditional Use Permit (Chapter <u>22.158</u>), pursuant to this Chapter for all other requirements, seven years.
- 2. Existing uses that are entirely or partially located between a 101-foot radius and a 500-foot radius of any lot containing a sensitive use and:
- a.

Subject to a Ministerial Site Plan (Chapter 22.186), pursuant to this Chapter for the requirements specified in Subsections C.1.a through C.1.j, except for C.1.d (Building Enclosure) or subject to Subsection C.3.c (Standards for Specific Uses, Warehouses) of <u>Section 22.84.030</u>, five years;


- b. Subject to a Ministerial Site Plan (Chapter 22.186), pursuant to this Chapter for the requirements specified in Subsection C.1.d (Building Enclosure) along with or without any other requirements of Section 22.84.030, seven years; or
- c. Subject to a Conditional Use Permit (Chapter 22.158), pursuant to this Chapter, seven years. Uses that are subject to a Conditional Use Permit, pursuant to this Chapter shall be brought into full compliance with all applicable requirements of this Chapter, no later than no later than seven years from the effective date of the this ordinance, or cease operations.
- 3. All existing uses that have been operating with an approved discretionary land use permit prior to the effective date of this ordinance, as provided by this <u>Title 22</u>, shall be brought into full compliance with all applicable requirements of this Chapter upon a renewal of such permits or requirement for a new discretionary permit.
- 4. Compliance shall be defined solely for this Chapter as the implementation and/or construction of all required development standards for uses subject to <u>Chapter 22.84</u> within the timeframe identified in Table 22.84.040-A. For properties requiring improvements that fall into multiple compliance years, the longer timeline shall apply to all improvements.
- 5. Prohibited uses shall not be granted any time extension beyond their grant term, and shall not be subject to <u>Chapter 22.172</u>.

(<u>Ord. 2022-0023</u> § 25, 2022.)

22.84.050 - Green Zone Districts Map.

The boundaries of the Green Zone District communities are shown on Figure 22.84.050-A: Green Zone Districts Boundaries, below.

FIGURE 22.84.050-A: GREEN ZONE DISTRICTS BOUNDARIES

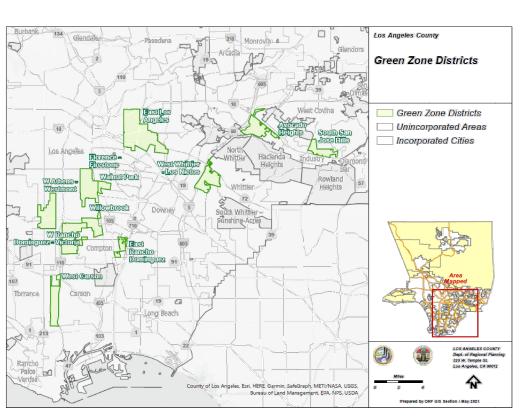

(Ord. 2022-0023 § 25, 2022.)

SUBMITTAL
CITY SUBMITTAL
10/25/23

REVISION
DATE

LADBS STAMP

CLIENT:

CM220364

JOB NO.

Rexford Industric

Rexfor Indust

Z

ORD INDUSTRIAL RE

DANIEL R.
SWIFT
C-32860



BSBDESIGN.COM

SHEET NO.

STANDARDS

G002

GREEN ZONE DEVELOPMENT

SUBMITTAL SET 02/06/2024

Chapter 22.350 - WEST RANCHO DOMINGUEZ-VICTORIA COMMUNITY STANDARDS DISTRICT

22.350.010 - Purpose.

The West Rancho Dominguez-Victoria Community Standards District ("CSD") is established to implement the goals and policies of the West Rancho Dominguez-Victoria Land Use Plan and Implementation Program.

Furthermore, this Chapter is intended to mitigate potential incompatibilities associated with the close proximity of industrial and residential zoning and land use within this CSD and to enhance the appearance of this CSD by setting forth development and building standards.

(Ord. 2019-0004 § 1, 2019.)

22.350.020 - Definitions.

The following terms are defined solely for this CSD:

Commercial horse stable. A facility used for the business of stabling horses and for services related to the maintenance and care of the horses stabled at the facility.

(Ord. 2019-0004 § 1, 2019.)

22.350.030 - District Map.

The boundaries of this CSD are shown on Figure 22.350-A: West Rancho Dominguez-Victoria CSD Boundary, at the end of this Chapter.

(Ord. 2019-0004 § 1, 2019.)

22.350.040 - Applicability.

(Reserved)

22.350.050 - Application and Review Procedures.

(Reserved)

22.350.060 - Community Wide Development Standards.

- A. Graffiti. To encourage the maintenance of exterior walls free from graffiti, the following shall apply to all premises within this CSD:
- 1. All structures, walls, and fences open to public view shall remain free of graffiti.

In the event such graffiti occurs, the property owner, lessee, or agent thereof shall remove such graffiti within 72 hours, weather permitting. Paint utilized in covering such graffiti shall be of a color that matches, as closely as possible, the color of the adjacent surfaces.

- B. Oil Well Properties. To improve the visual appearance of this CSD, properties containing oil wells where active extraction is taking place shall be fenced and landscaped in accordance with the following requirements:
- 1. For properties abutting a Residential Zone or a street, a solid masonry wall or solid fence in compliance with Section 22.140.430.C.2 (Fences and Walls) or a fence in compliance with Section 11.48.030 (Fencing Specifications) in Title 11 (Health and Safety) of the County Code shall be erected around each oil well. The wall or fence shall be not less than six feet in height and shall be provided with landscaping in accordance with Section 22.140.430.C.4 (Landscaping Requirements). The required landscaping for any fence erected in compliance with Section 11.48.030 in Title 11 shall be planted so as to completely screen the fence within five years from the date of erection of the fence.
- 2. All oil well equipment, structures, facilities and sites shall be maintained in good condition and accumulations of trash and debris shall be removed regularly.

C. Commercial Horse Stables.

- 1. Commercial horse stables and other commercial uses that use horse stables are permitted in Zone M-1.5 and higher. To ensure that these uses are developed and used in a safe and orderly manner and are compatible with existing land use patterns, these uses shall comply with the following:
- a. Feed Storage Area. The facility shall have a feed storage area sufficient in size to accommodate the feed necessary for all horses kept at the facility and an unblocked, clear path for access to and from such feed storage area;
- b. Manure Management Area. The facility shall have a manure management area with manure containers stored in a place or direction sufficiently away from the feed storage area and horse stalls to avoid unhealthful conditions for the horses;
- c. Tack Storage Area. The facility shall have a tack storage area with sufficient space for the storage and maintenance of riding tack for the horses kept at the facility;
- d. Water Storage Area. Each horse stall in the facility shall have a water storage area with an adequate delivery method of water of sufficient size for the horse kept in that stall;
- e. Wash Rack Area. The facility shall have a wash rack area sufficient in size to accommodate the number of horses kept at the facility;
- f. Horse Stall Size and Construction. Each horse stall within the facility shall have a minimum length, height, and width of 12 feet and shall be constructed in a workmanlike manner.

 The horse stalls shall be constructed of fire-resistant material appropriate for equine

containment facilities. No more than one horse shall be permitted to be stabled in any horse stall;

- g. Horse Stall Access Area. Each horse stall within the facility shall have a minimum access area of 12 feet in width for the ingress and egress and the access area shall be clear and accessible at all times. If the horse stall access area is covered, the cover shall have a minimum height of 12 feet;
- h. Horse Recreation Area.
- i. For any facility that is not adjacent to a publicly-designated riding area or equestrian trail, the facility shall have a horse recreation area that contains the following:
- (1) A minimum of one 50-foot diameter round pen for a facility that has a maximum of 25 horse stalls and an additional pen of these dimensions for every additional increment of one to 25 horse stalls at the facility; plus
- (2) A minimum of one 60-foot by 100-foot riding arena for any facility that has a maximum of 50 horse stalls and an additional riding arena of these dimensions for every additional increment of one to 50 horse stalls at the facility.

- ii. The horse recreation areas shall be for use only by the horses stabled at the facility;
- iii. Temporary uses within the horse recreation area may be permitted with an approved Special Event Permit (Chapter 22.188);
- i. Fences or Walls. The facility shall have a perimeter fence or wall with a minimum height of six feet and a maximum height of 10 feet. All fences or walls shall be of uniform height, built in a workmanlike manner, and constructed solely of new materials. No chain link fencing shall be permitted for this purpose; and
- j. Parking. The facility shall have a minimum of one vehicle parking space, eight and one-half feet in width by 18 feet in depth, plus one vehicle parking space, nine feet in width by 44 feet in depth, for every increment of one to four horse stalls at the facility. Adequate
- access to these required parking spaces shall also be provided. Other than as specified above, parking spaces shall be developed in accordance with Chapter 22.112 (Parking).
- 2. Maintenance. The facility shall be neatly maintained and free of junk and salvage, and all structures, including but not limited to the horse stalls, horse recreation areas, and fences or walls, shall be maintained in good condition at all times.
- 3. Site Plan Depiction. Compliance with the requirements of Subsection C.1, above, shall be depicted on an approved site plan for the commercial horse stable or other commercial use that uses a horse stable.
- 4. Additional Requirements. The requirements in this Subsection C shall be in addition to any other applicable requirements in the County Code related to the uses governed by this Subsection C.

(Ord. 2019-0004 § 1, 2019.)

22.350.070 - Zone Specific Development Standards.

A. Zone R-1.

- 1. The required front yard shall contain a minimum of 50 percent landscaping.
- 2. Where the rear yard abuts an Industrial Zone, a three-foot landscaped planter strip containing one 15-gallon tree for each 50 square feet of planter area shall be installed along the rear property line. This provision shall not apply to the section of the rear yard where garages or accessory structure may be erected.
- B. Zone R-2. The requirements specified in Zone R-1 of this Section shall apply to Zone R-2.
- C. Zone C-2. Vehicle parking requirements for the following uses shall be modified as follows:

 Markets of less than 5,000 square feet, banks, bookstores, delicatessens, drug stores, and office supply stores shall provide a minimum of one parking space for every 400 square feet of gross floor area. Restaurants of less than 1,000 square feet of gross floor area shall provide a minimum of five parking spaces, and restaurants of at least 1,000 square feet of gross floor area shall be granted a maximum 25 percent reduction of the otherwise required parking.

D. Zone C-3.

- 1. The vehicle parking requirements specified in Zone C-2 of this Section shall apply to Zone C-3.
- 2. A building or structure shall not exceed a height of 45 feet above grade, excluding chimneys and rooftop antennas.

E. Zone C-M.

- Buildings and structures shall be set back a minimum of ten feet from the front property line.
 The front 10 feet of the setback, not including access, parking, and circulation areas, shall be landscaped.
- 2. For properties abutting a Residential Zone, a landscaped buffer of at least five feet shall be provided and shall be automatically irrigated by a permanent watering system. One 15-gallon tree for every 50 square feet of landscaped area shall be planted equally spaced within the buffer strip.
- 3. For properties abutting a Residential Zone, a solid masonry wall or solid fence of at least eight feet in height in compliance with Section 22.140.430.C.2 (Fences and Walls) shall be erected along the property lines separating the two uses.
- 4. To mitigate noise, all loading docks shall be located as far distant as feasible from adjoining Residential Zones.
- 5. A building or structure located within 250 feet of a Residential Zone shall not exceed a height of 45 feet above grade, excluding chimneys and rooftop antennas.
- 6. A building or structure located more than 250 feet from a Residential Zone shall not exceed a height of 90 feet above grade, excluding chimneys and rooftop antennas.
- 7. The maximum lot coverage shall not exceed 70 percent.
- 8. All uses except for parking, vending machines, shopping carts, and accessory uses shall be conducted entirely within a building.
- 9. Outside storage shall not be visible by pedestrians on adjacent residentially zoned streets or by persons on neighboring residentially zoned properties.

F. Zone M-1.

- 1. The requirements specified in Zone C-M of this Section shall apply to Zone M-1.
- 2. All activities conducted outside an enclosed structure and located within 500 feet of a Residential Zone, except for parking, vending machines, shopping carts, and accessory uses, shall require a Conditional Use Permit (Chapter 22.158).
- 3. For properties abutting a Residential Zone, the following uses shall require a Conditional Use Permit (Chapter 22.158):
 - Acetylene, the storage of oxygen and acetylene;
- Automobile body and fender repair shops;
- Automobile painting and upholstering;
- Batteries, the manufacture and rebuilding of batteries;
- Blacksmith shops;
- Building materials, storage of;
- Bus storage;
- Cannery, except meat or fish;
- Car barns for buses and street cars;
- Cellophane, the manufacture of cellophane products;
- Cesspool pumping, cleaning and draining;

- Concrete batching, provided that the mixer is limited to one cubic yard capacity;
- Explosives storage;
- Fuel yard;
- Generators, the manufacture of electrical generators;
- Granite, the grinding, cutting, and dressing of;
- Lumberyards, except the storage of boxes or crates;
- Marble, the grinding, cutting, and dressing of;
- Stone, marble, and granite, and grinding, dressing, and cutting of;
- Tire retreading;
- Truck storage or rental;
- Wood yards.
- 4. Notwithstanding the provisions of Subsection F.3, above, premises in Zone M-1 may be used for the following accessory uses:
 - Acetylene, the storage of oxygen and acetylene;
- Building materials, storage of;
- Concrete batching, provided that the mixer is limited to one cubic yard capacity;
- Truck storage.
- 5. The minimum lot size shall be 10,000 square feet with a minimum lot width of 75 feet. Lots legally created prior to the effective date of the ordinance establishing this CSD shall not be required to comply with this requirement.
- G. Zone M-1.5. The requirements specified in Zones C-M and M-1 of this Section shall apply to Zone M-1.5.

H. Zone M-2.

- 1. The requirements specified in Zone C-M and Zone M-1 of this Section shall apply to Zone M-2.
- 2. Automobile dismantling yards, junk salvage yards, and scrap metal processing yards shall not be permitted within 500 feet of a Residential Zone.
- 3. Automobile dismantling yards, junk and salvage yards, and scrap metal processing yards shall
- provide a wall or fence of at least eight feet in height in compliance with Section 22.140.430.C.2 (Fences and Walls) along all street frontages. The wall or fence shall be set back at least three feet from property lines having street frontage. The setback area shall be landscaped with shrubs, and one 15-gallon tree for every 50 square feet of landscaped area
- shall be planted equally spaced within the setback.4. The minimum lot size shall be 20,000 square feet with a minimum lot width of 100 feet. Lots legally created prior to the effective date of the ordinance establishing this CSD shall not be required to comply with this requirement.
- I. Zone B-1.
 - 1. Accessory uses. Premises shall not be used for accessory buildings and structures.
 - 2. Prohibited uses. Premises shall not be used for outside storage or for the parking of vehicles for over 72 continuous hours.
- J. Zone B-2. The requirements specified in Zone B-1 of this Section shall apply to Zone B-2.

(Ord. 2021-0010 § 44, 2021 ; Ord. 2019-0004 § 1, 2019.)
22.350.080 - Area Specific Development Standards.


(Reserved)

22.350.090 - Modification of Development Standards.

With the exception of the Section 22.350.060.C.1.j (Parking), any modification from the requirements set forth in Section 22.350.060.C.1 shall require a Conditional Use Permit (Chapter 22.158) application. With respect to the parking requirements in Section 22.350.060.C.1.j (Parking), a modification can be obtained through any applicable method under this <u>Title 22</u> that authorizes a reduction in required parking.

(Ord. 2019-0004 § 1, 2019.)

FIGURE 22.350-A: WEST RANCHO DOMINGUEZ-VICTORIA CSD BOUNDARY

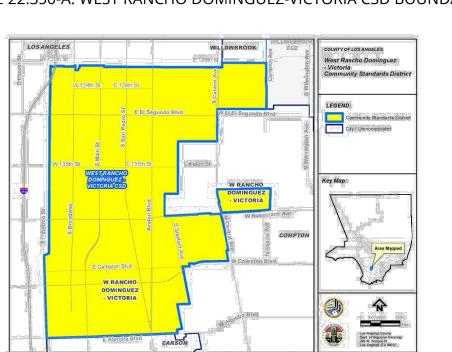

REVISION DATE

LADBS STAMP

CM220364

DATE

JOB NO.

SUBMITTAL

CLIENT:

Rexford
Industrial

OUSTRIAL REALTY
A ST.
USTRIAL REALTY

1400 S FIGUEROA ST.
ARDENA, CA 90248
ENT:

DANIEL R. SWIFT

C-32860

PARCHITECT

C-32860



SHEET TITLE
COMMUNITY STANDARDS
DISTRICT (CSD) NOTES


SHEET NO.

G003

SUBMITTAL SET 02/06/2024





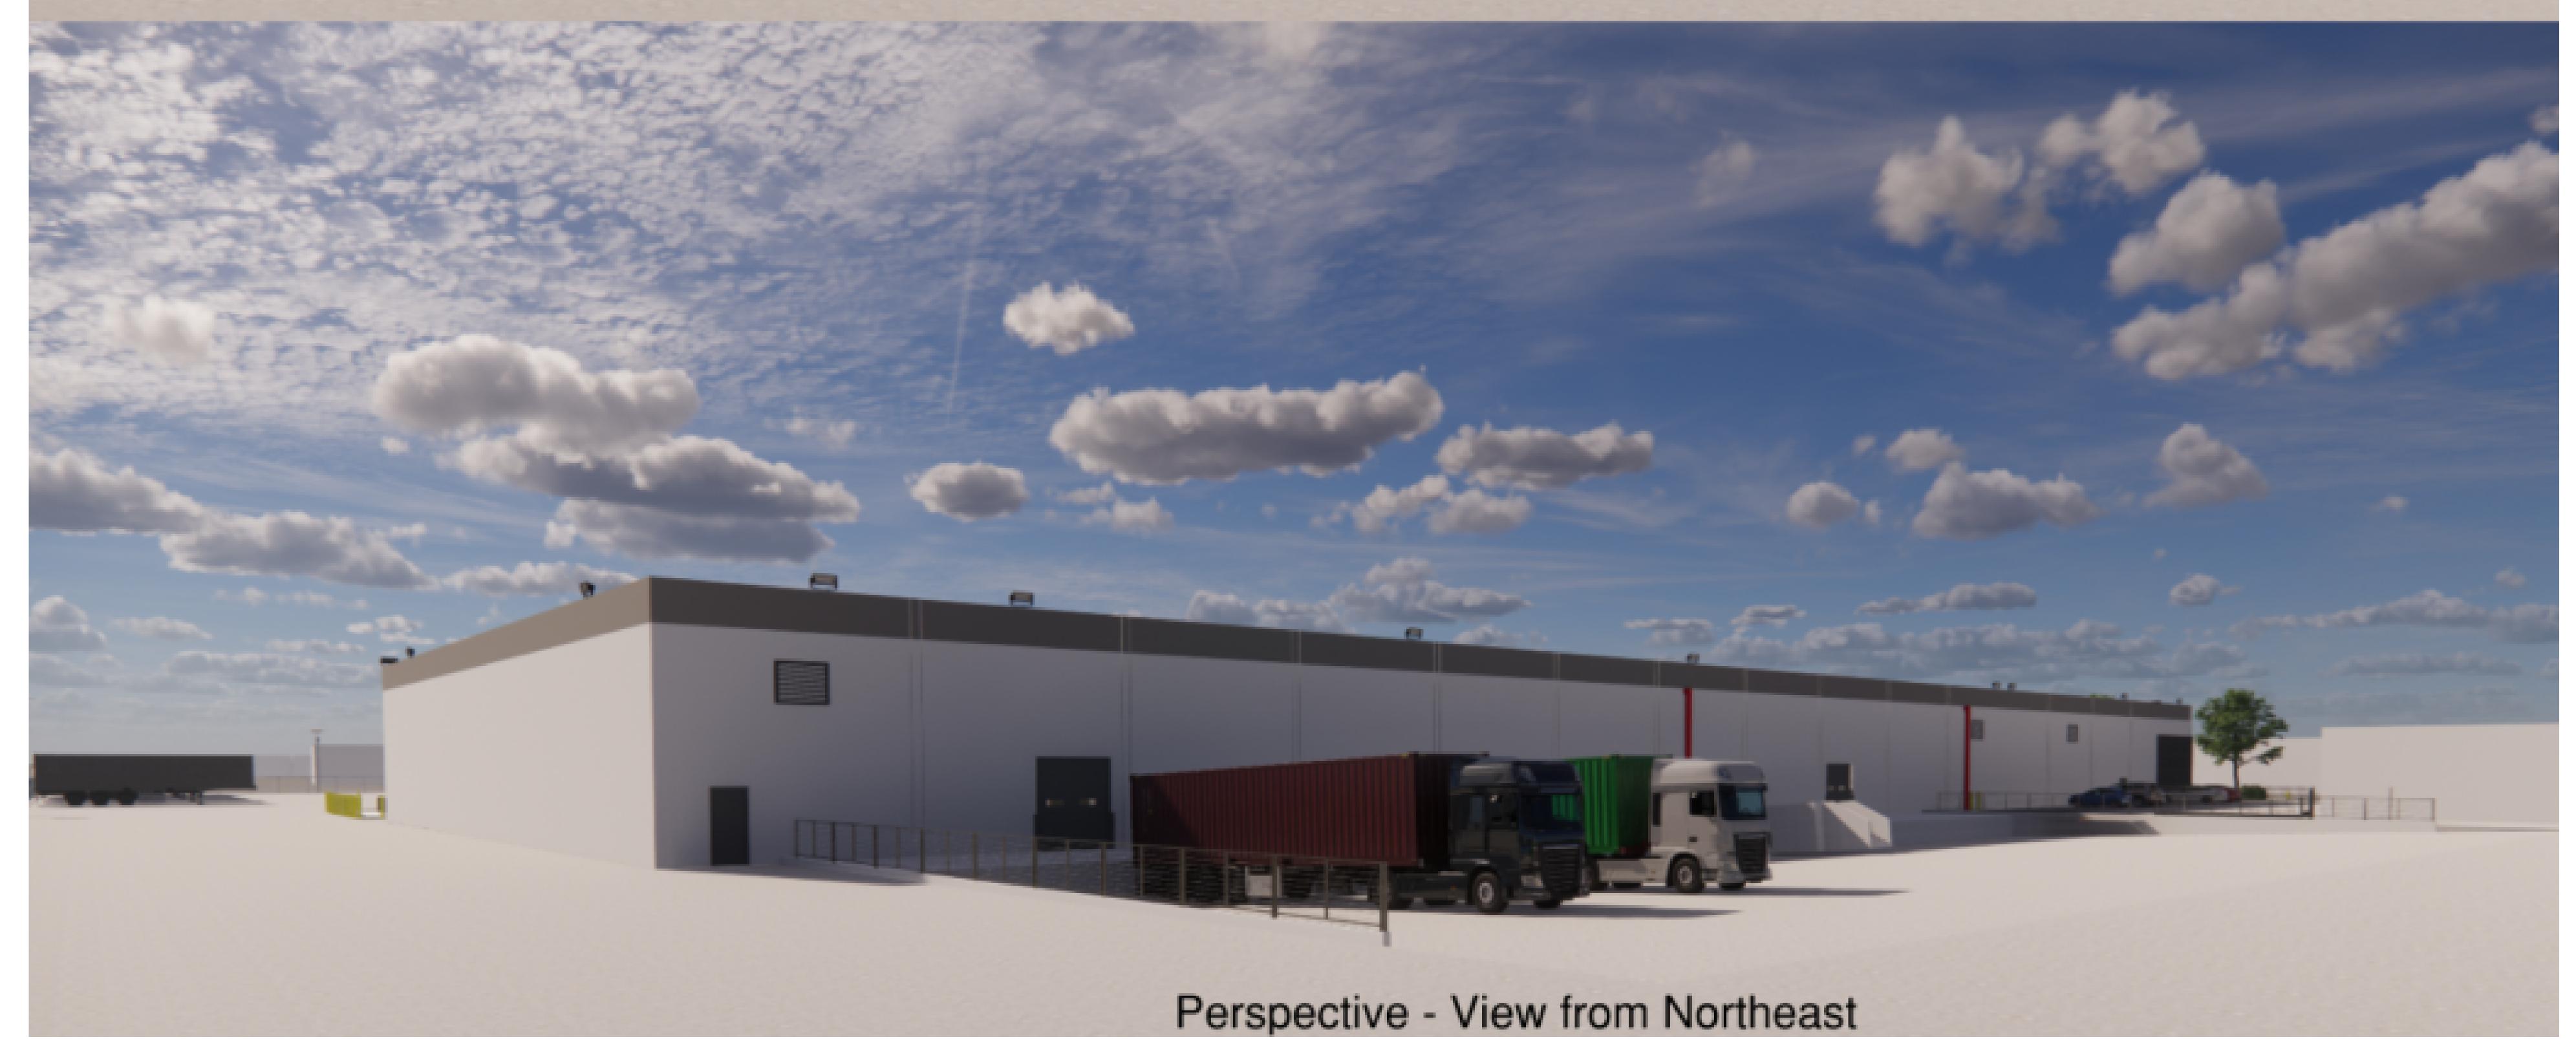

TENANT IMPROVEMENT FOR:

14400 S FIGUEROA STREET, GARDENA, CA 90248 REXFORD INDUSTRIAL REALTY

11620 Wilshire Boulevard, Suite 610 Los Angeles, CA 90024

REET TREES WITHIN THE PUBLIC RIGHT-OF-WAY ARE TO BE ANTED PER APPROVED STREET IMPROVEMENT PLANS.	WATER AUDIT NOTE:	
EE CANOPIES ARE SHOWN IN FULL MATURITY	THE CONTRACTOR WILL CONDUCT AN IRRIGATION AUDIT USING A CERTIFIED IRRIGATION AUDITOR, AFTER THE I OBSERVATION HAS BEEN COMPLETED AND ALL IRRIGATION COMPONENTS ARE INSTALLED IN ACCORDANCE WIT	
L HARDSCAPE, RETAINING WALL, SWIMMING POOLS, AND / R BLOCK WALL MUST BE REVIEWED AND APPROVED UNDER SEPARATE PERMIT	SPECIFICATION AND THE IRRIGATION SYSTEM IS ACCEPTED BY THE PROJECT ARCHITECT FOR MAINTENANCE. THE IRRIGATION AUDIT WILL BE CONDUCTED IN ACCORDANCE WITH THE FOLLOWING SCHEDULE.	H THE PLAINS
L PLANTS IN IS IN COMPLIANCE WITH THE DROUGHT DLERANT LANDSCAPE (DTL)	1. PL.ACE FLAGS AT EACH HEAD IN THE ZONE.	
IE TYPE OF SOIL IS SUITABLE FOR ALL THE PROPOSED ANTS IN THIS LANDSCAPE	 MEASURE SPACING AND MARK MID POINTS BETWEEN HEADS. PL.ACE WATER MEASURING RECEPTACLES. TAKE READINGS OF WATER LEVEL IN RECEPTACLES AND RECORD RESULTS. 	
INTRACTOR TO PROTECT AN PRESERVE IN PLACE ALL ISTING SURVEY MONUMENTS. ANY MONUMENTS STURBED SHALL BE RESET BY A LICENSED LAND SURVEYOR ID THE APPROPRIATE CORNER RECORD MUST BE FILED	 MEASURE HEAD PRESSURE IN EACH ZONE AND RECORD RESULTS. AFTER COMPLETING ZONE ADVANCE TO NEXT ZONE AND REPEAT PROCEDURE. SUBMIT THE RESULTS OF THE AUDIT TO THE PROJECT ARCHITECT THE IRRIGATION MAINTENANCE SCHEDULE TASKS LISTED BELOW ARE INTENDED AS MINIMUM STANDARDS AND 	MORE EREOU
TH THE COUNTY OF LOS ANGELES	ATTENTION MAY BE REQUIRED DEPENDING ON THE PARTICULAR SITE CONDITIONS.	WORLTREGO
L LANDSCAPE AREAS AND IRRIGAITON SHALL BE AND IRRIGAITON SHALL BE		
OPERTY IS NOT LOCATED IN THE VHFHSZ. GERMAN GUILERA, INSPECTOR 12C, FUEL MODIFICATION UNIT URBAN PRESTRY DIVISION LOS ANGELES COUNTY FIRE DEPT. 62)860-8014	MAINTENANCE TASK CONTROLLER CABINET-OPEN CABINET AND CLEAN OUT DEBRIS AND REPLACE BATTERY AS NECESSARY. CHECK WIRING AND REPAIR AS NEEDED AND CHECK CLOCK AND RESET IF NECESSARY.	FREQUENC QUARTERL
TAL LANDSCAPE AREA: 13,191 SQUARE FEET	IRRIGATION SCHEDULE-ADJUST SCHEDULE FOR SEASONAL VARIATIONS AND OTHER CONDITIONS	MONTHLY
EE CANOPIES ARE SHOWN AT FULL MATURITY	WHICH MAY AFFECT THE AMOUNT OF WATER NEEDED TO MAINTAIN PLANT HEALTH ADJUST AS NECESSARY.	
	POC- VISUALLY INSPECT COMPONENTS FOR LEAKS, PRESSURE SETTINGS, SETTLEMENT OR OTHER DAMAGE AFFECTING THE OPERATION OF A COMPONENT REPAIR AS NEEDED.	QUARTERL
	REMOTE CONTROL VALVES, ISOLATION VALVES AND QUICK COUPLER VALVES VISUALLY INSPECT FOR LEAKS, SETTLEMENT, WIRE CONNECTIONS AND PRESSURE SETTINGS. REPAIR OR ADJUST AS NEEDED.	QUARTERL
	MAINLINE & LATERALS VISUALLY INSPECT FOR LEAKS OR SETTLEMENT OF TRENCH.	QUARTERL
	SPRINKLERS VISUALLY CHECK FOR ANY BROKEN MISSING OR CLOGGED HEADS , HEADS WITH INCORRECT ARC, INADEQUATE COVERAGE OR OVERSPRAY AND LOW HEAD DRAINAGE REPAIR AS NEEDED.	WEEKLY
	FILTERS AND STRAINERS VISUALLY CHECK FOR LEAKS, BROKEN FITTING CLEAN AND FLUSH SCREENS.	MONTHLY
	AUDIT SHALL BE IN ACCORDANCE WITH THE LATEST STATE OF CALIFORNIA LANDSCAPE WATER MANAGEMENT FOR DESCRIBED IN THE LATEST LANDSCAPE IRRIGATION AUDITOR HANDBOOK. THE LANDSCAPE IRRIGATION AUDITS CONDUCTED BY A QUALIFIED INDIVIDUAL AND THE AUDIT SCHEDULE SHALL BE CONDUCTED AT LEAST ONCE EVIL ACCORDANCE WITH THE REQUIREMENTS OF TITLE 20. DIVISION 1 OF THE LOS ANGELES COUNTY CODE.	S TO BE

ANDSCAPE SHALL BE MAINTAINED TO ENSURE WATER EFFICIENCY. A REGULAR MAINTENANCE SCHEDULE SHALL INCLUDE, BUT NOT BE LIMITED TO, CHECKING, ADJUSTING, AND REPAIRING

LANDSCAPE IRRIGATION AUDIT SCHEDULES. A SCHEDULE OF LANDSCAPE IRRIGATION AUDITS OF AT LEAST EVERY FIVE YEARS MUST BE ESTABLISHED, FOR ALL BUT SINGLE-FAMILY RESIDENCES, AND

OTHER PROJECTS WITH A LANDSCAPE AREA LESS THAN 1 ACRE (0.405 HA). AS REQUIRED IN CHAPTER 20.09 OF TITLE 20 (UTILITIES CODES), AN AUDIT SATISFYING THE FOLLOWING CONDITIONS SHALL

AT A MINIMUM, AUDITS SHALL BE IN ACCORDANCE WITH THE LATEST STATE OF CALIFORNIA LANDSCAPE WATER MANAGEMENT PROGRAM AS DESCRIBED IN THE LANDSCAPE IRRIGATION AUDITOR

HANDBOOK, PREPARED FOR THE CALIFORNIA DEPARTMENT OF WATER RESOURCES, WATER CONSERVATION OFFICE, THE ENTIRE DOCUMENT, WHICH IS HEREBY INCORPORATED BY REFERENCE.

	REXFORD INDUSTRIAL REALTY
	11620 WILSHIRE BLVD Suite 610
	LOS ANGELES, CA 90024
	(424) 440-2565
	NAME: Brian Garcia bgarcia@rexfordindustrial.com
CONS	ULTANT INFORMATION
ARCH	ITECT for Shell Building
	BSB DESIGN INC.
	970 W. 190TH STREET SUITE 250
	TORRANCE, CA 90502
	Office (310) 217-8885
	Direct (424) 266-6942
	Contact: Dan Torres dtorres@bsbdesign.com
LAND	SCAPE ENGINEER
LAND	CUMMINGS CURLEY AND ASSOCIATES
LAND:	
LAND:	CUMMINGS CURLEY AND ASSOCIATES
LAND:	CUMMINGS CURLEY AND ASSOCIATES 1700 PACIFIC COAST HIGHWAY SUITE C
LAND:	CUMMINGS CURLEY AND ASSOCIATES 1700 PACIFIC COAST HIGHWAY SUITE C SEAL BEACH, CA 90740
LAND	CUMMINGS CURLEY AND ASSOCIATES 1700 PACIFIC COAST HIGHWAY SUITE C SEAL BEACH, CA 90740
	CUMMINGS CURLEY AND ASSOCIATES 1700 PACIFIC COAST HIGHWAY SUITE C SEAL BEACH, CA 90740 Office (562) 424-8181
	CUMMINGS CURLEY AND ASSOCIATES 1700 PACIFIC COAST HIGHWAY SUITE C SEAL BEACH, CA 90740 Office (562) 424-8181 Contact: ROBERT L. CURLEY robert@cummingscurley.com
	CUMMINGS CURLEY AND ASSOCIATES 1700 PACIFIC COAST HIGHWAY SUITE C SEAL BEACH, CA 90740 Office (562) 424-8181 Contact: ROBERT L. CURLEY robert@cummingscurley.com ENGINEER
	CUMMINGS CURLEY AND ASSOCIATES 1700 PACIFIC COAST HIGHWAY SUITE C SEAL BEACH, CA 90740 Office (562) 424-8181 Contact: ROBERT L. CURLEY robert@cummingscurley.com ENGINEER CANNON
	CUMMINGS CURLEY AND ASSOCIATES 1700 PACIFIC COAST HIGHWAY SUITE C SEAL BEACH, CA 90740 Office (562) 424-8181 Contact: ROBERT L. CURLEY robert@cummingscurley.com ENGINEER CANNON 16842 Von Karman Avenue
	CUMMINGS CURLEY AND ASSOCIATES 1700 PACIFIC COAST HIGHWAY SUITE C SEAL BEACH, CA 90740 Office (562) 424-8181 Contact: ROBERT L. CURLEY robert@cummingscurley.com ENGINEER CANNON 16842 Von Karman Avenue Irvine, CA 92606

OWNER INFORMATION

PROJECT A	DDRESS:
	14400 S FIGUEROA ST. GARDENA, CA 90248 400 W ROSECRANS AVE. GARDENA, CA 90248
ZONED:	
	M2-1VL-O (LIGHT MANUFACTURING)
ASSESSOR	PARCEL NO. (A.P.N.):
	6129-001-029 CITY OF LOS ANGELES JURISDICTION
	6129-001-028 COUNTY OF LOS ANGELES JURISDICTION
	6129-001-023 COUNTY OF LOS ANGELES JURISDICTION
	6129-*001-024 COUNTY OF LOS ANGELES JURISDICTION
SCOPE OF	WORK:
	THE TENANT IMPROVEMENT CONSISTS OF THE FOLLOWING: • DEMOLISHING OF TWO BUILDINGS AND A PORTION OF A BUILDING, • DEMOLISHING OF INTERIOR OFFICE SPACES AND MEZZANINE, • NEW OFFICE SPACE WITHIN THE EXISTING WAREHOUSE WITH NEW ACCESSIBLE RESTROOMS, • NEW SITE CONDITIONS
AREA OF W	ORK:
	TOTAL LOT AREA: 253,350 SQ. FT.
SITE AREA:	
	All Parcels: 271,847 sf

recommendations. Soils testing shall be completed and test results and amendment

approved equal as approved by the Owner's Representative.

University of California Soil Fertility Test.

results of the soils tests.

8. Soil analysis shall include A. Soil texture B. Infiltration rate

D. Total soluble salts

F. Percent organic matter G. Recommendations

E. Sodium

recommendations submitted to the Owner's Representative a minimum of sixty (60) days before

2. The testing laboratory shall be WALLACE LABORATORIES, LLC 365 Coral Circle El Segundo, CA

3. The testing laboratory for soils analysis shall use the following criteria for soil testing: USDA

Agricultural Suitability Test per Handbook 60, to include Boron presence and content; and

4. Interpretations, fertilization and soil amendment recommendations, and comments regarding these

5. Soils test sites shall occur not more than 250 feet on center in the planting areas, unless otherwise

6. Samples of all import soil from each source shall also be submitted to the soils testing laboratory for analysis, interpretation and recommendations prior to placement, blending or back-filling.

7. A copy of the plant schedule shall be provided to the lab for review and comment in relation to the

Provide soil analysis report to the local agency as part of the **Certificate of Completion** due to mass

commencement of any planting. The report shall be reviewed approved by the project Landscape

Architect and ALL required governing agencies PRIOR to the commencement of any soil amending

90245 phone (310) 615-0116 or approved equal as approved by the Owner's Representative., or

SOIL TESTS FOR SOIL MANAGEMENT

L000	COVER SHEET
L100	PLANTING PLAN
L101	PLANTING NOTES
L200	IRRIGATION PLAN
L201	IRRIGATION NOTES
L300	LANDSCAPE DETAILS
L301	LANDSCAPE DETAILS
L400	LANDSCAPE SPECIFICATIONS
L401	LANDSCAPE SPECIFICATIONS
L402	LANDSCAPE SPECIFICATIONS



ัติ CLIENT:

SUBMITTAL

REVISION

LADBS STAMP

Bid Addendum 'C'.

CLIENT SUBMITTAL

CLIENT RE-SUBMITTAL

CM220364

10/18/23

02.21.24

06.21.24



COVER SHEET

SHEET NO. L000

SHEET 1 OF 10

BSBDESIGN.COM

E SCHEDULE SHALL PROVIDE FOR LANDSCAPE IRRIGATION AUDITS TO BE CONDUCTED BY A QUALIFIED INDIVIDUAL AS DETERMINED BY THE DIRECTOR	AT LEAST ONCE EVERY FIVE YEARS IN

LOS AN	GELES COUNTY FIRE PREVENTION
	FUEL MODIFICATION UNIT
	LOS ANGELES COUNTY FIRE DEPARTMENT
	(562)860-8014

ACCORDANCE WITH THE REQUIREMENTS OF TITLE 20, DIVISION 1 OF THE LOS ANGELES COUNTY CODE.

A LANDSCAPE IRRIGATION AUDIT SCHEDULE AS REQUIRED IN CHAPTER 20.09 OF TITLE 20 MAY BE

BE SUBMITTED TO THE COUNTY AS PART OF THE LANDSCAPE DOCUMENTATION PACKAGE.

RECOMMENDED. THE MAXIMUM PERIOD BETWEEN AUDITS SHALL BE FIVE YEARS.

IRRIGATION AUDIT SCHEDULES:

GOLDEN STATE WATER COMPANY STATIC WATER PRE

WATER EFFICIENT LANDSCAPE WORKSHEET

14440 FIGUEROA STREET

This worksheet is filled out by the project applicant and it is a required element of the

Hydrozone # /Planting Description ^a	Plant Factor (PF)	ation (ETo) Irrigation Method ^b	Irrigation Efficiency	ETAF (PF/IE)	Landscape Area (sq, ft,)	ETAF x Area	Estimated Total Water Use
Regular Landscap	e Areas		(IE) ^c	1		<u> </u>	(ETWU) ^e
SHRUBS / GRUND COVER	0.20	DRIP	.85	0.24	3,037.71	750.05	18,461.78
TREES	0.20	CRIP	.80	.025	226.08	55.82	1,374.01
				Totals	3,264 ^{A)}	805.89	19,836
Special Landscape	e Areas						
				1			
				1			
				1			
				Totals	(C)	(D)	
						ETWU Total	19,836
			Maxi	imum Allowe	d Water Allowa	nce (MAWA) ^e	36,954

Hydrozone #/Planting Description E.g 1.) front lawn 2.) low water use plantings 3.) medium water use planting	^b irrigation Method overhead spray or drip	^c Irrigation Efficiency 0.75 for spray head 0.81 for drip	dETWU (Annual Gallons Required) = Eto x 0.62 x ETAF x Area where 0.62 is a conversion factor that converts acre- inches per acre per year to
[®] MAWA (Annual Gallons Allowed) = (+ ((1-ETAF) x SLA)]	Eto) (0.62) [(ETAF x LA)		gallons per square foot per year.
where 0.62 is a conversion fa			
inches per acre per year to ga			
year, LA is the total landscape			
is the total special landscape and ETAF is .55 for residentia			
and Fivi is 100 to lesidente	ii ai cas ai iu v.45 ivi iivii-		

ETAF Calculations

Average ETAF	B÷A	0.24
Total Area	(A)	3,264
Total ETAF x Area	(B)	805.8
Regular Landscape Area		T-0-

Average ETAF for Regular Landscape Areas must be 0.55 or below for residential areas, and 0.45 or below for non-residential areas.

Sitewide ETAF (B+D) ÷ (A	
otal Area (A+	-C) 3,264
otal ETAF x Area (B+	-D) 805.87

A copy of this form may be obtained from Department of Water Resources website: http://www.water.ca.gov/wateruseefficiency/landscapeordinance/

BUILDING DEPARTMENT

RESSURE: 50 /110	LOS ANGELES COUNTY	
	COUNTY OF LOS ANGELES	
	320 W TEMPLE ST. STE 13	
	LOS ANGELES, CA 90012	
	Office (213) 974-6411	

ROSECRANS AVENUE

WATER EFFICIENT LANDSCAPE WORKSHEET

Landscape Documentation Package.

Hydrozone # /Planting Description ^a	Plant Factor (PF)	Irrigation Method ^b	Irrigation Efficiency (IE) ^c	ETAF (PF/IE)	Landscape Area (sq, ft,)	ETAF x Area	Estimated Tota Water Use (ETWU)°
Regular Landscap	e Areas				,		
SHRUBS / GRUND COVER	0.20	DRIP	.85	0.24	3780.53	889.54	21,895.05
TREES	0.20	CRIP	.80	.025	339.12	87.74	2,086.77
				Totals	4,126 ^{A)}	974.592	23,982
Special Landscap	e Areas		•				-
				1			
				1			
				1			
				Totals	(C)	(D)	
				1		ETWU Total	23,982
			Max	imum Allowe	d Water Allowa	nce (MAWA) ^e	46,664

			40,004
^a Hydrozone #/Planting Description		^c irrigation Efficiency 0.75 for spray head 0.81 for drip	a ETWU (Annual Gallons Required) Eto x 0.62 x ETAF x Area where 0.62 is a conversion factor that converts acre- inches per acre per year to
 MAWA (Annual Gallons Allowed) = (Electric Head) + ((1-ETAF) x SLA)] where 0.62 is a conversion fact inches per acre per year to galleyear, LA is the total landscape at is the total special landscape. 	or that converts acre- ons per square foot per area in square feet, SLA		gallons per square foot per year.

ETAF Calculations

Average ETAF	B÷A	0.24
Total Area	(A)	4,120
Total ETAF x Area	(B)	974.32

(B+D) ÷ (A+C) 0.24	Sitewide ETAF
(A+C) 4,120	Total Area
(B+D) 974.32	Total ETAF x Area
	All Landscape Areas
	All Landscape Areas

http://www.water.ca.gov/wateruseefficiency/landscapeordinance/

Irozone #/Planting Description ont lawn w water use plantings edium water use planting	^b Irrigation Method overhead spray or drip	^c Irrigation Efficiency 0.75 for spray head 0.81 for drip	dETWU (Annual Gallons Required Eto x 0.62 x ETAF x Area where 0.62 is a conversion factor that converts acre- inches per acre per year to
WA (Annual Gallons Allowed) = (E I-ETAF) x SLA)] where 0.62 is a conversion fac inches per acre per year to gal year, LA is the total landscape is the total special landscape a and ETAF is .55 for residential	tor that converts acre- llons per square foot per area in square feet, SLA area in square feet,		gallons per square foot pe year.

Regular Landscape Areas

Average ETAF	B÷A	0.24
Total Area	(A)	4,120
Total ETAF x Area	(B)	974.32

Average ETAF for Regular Landscape Areas must be 0.55 or below for residential areas, and 0.45 or

itewide ETAF	(B+D) ÷ (A+C)	0.24
otal Area	(A+C)	4.120
otal ETAF x Area	(B+D)	974.32
All Landscape Areas	(B+D)	074.00

This worksheet is filled out by the project applicant and it is a required element of the


Hydrozone # /Planting Description ^a	Plant Factor (PF)	Irrigation Method ^b	Irrigation Efficiency (IE) ^c	ETAF (PF/IE)	Landscape Area (sq, ft,)	ETAF x Area	Estimated Total Water Use (ETWU)°
Regular Landscap	e Areas						
HRUBS / GRUND COVER	0.20	DRIP	.85	0.24	3780.53	889.54	21,895.05
TREES	0.20	CRIP	.80	.025	339.12	87.74	2,086.77
				Totals	4,126 ^{A)}	974.5	23,982
Special Landscape	e Areas			•			-
				1			
				1			
				1			
				Totals	(C)	(D)	
				1		ETWU Total	23,982
			Maxi	mum Allowe	d Water Allowa	nce (MAWA) ^e	46,664

i ciency ay head o	^d ETWU (Annual Gallons Required) = Eto x 0.62 x ETAF x Area where 0.62 is a conversion factor that converts acre- inches per acre per year to gallons per square foot per year.

below for non-residential areas.

A copy of this form may be obtained from Department of Water Resources website:


KEY MAP:

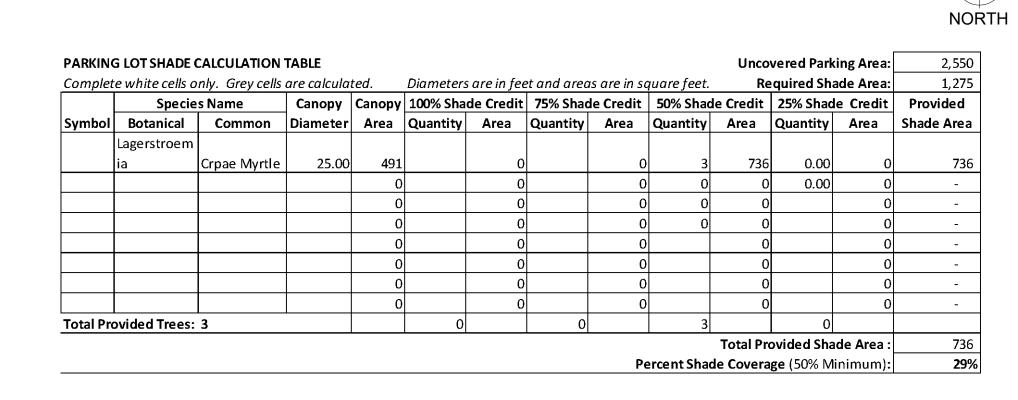

I agree to comply with the requirements of the water efficient landscape ordinance and submit a complete Landscape Documentation Package and I have complied with the criteria of the ordinance and applied them for the efficient use of water in the landscape design plans

REE REMOVAL SC	CHEDULE			§ WELL NO. 45	801			
REE: REMOVED	<u>QTY</u>	BOTANICAL / COMMON NAME	CONT. SIZE	WELL NO. 45	evi		G.H.	
\searrow	2	Cupressus sempervirens / Italian Cypress						ſ
	1	Olea europaea / Olive Multi-Trunk				[
							ROSECRANS	
								ĺ
								π { ι
							* * * * * * * * * * * * * * * * * * *	
								Ì

PROPOSED TREE REMOVAL PLAN

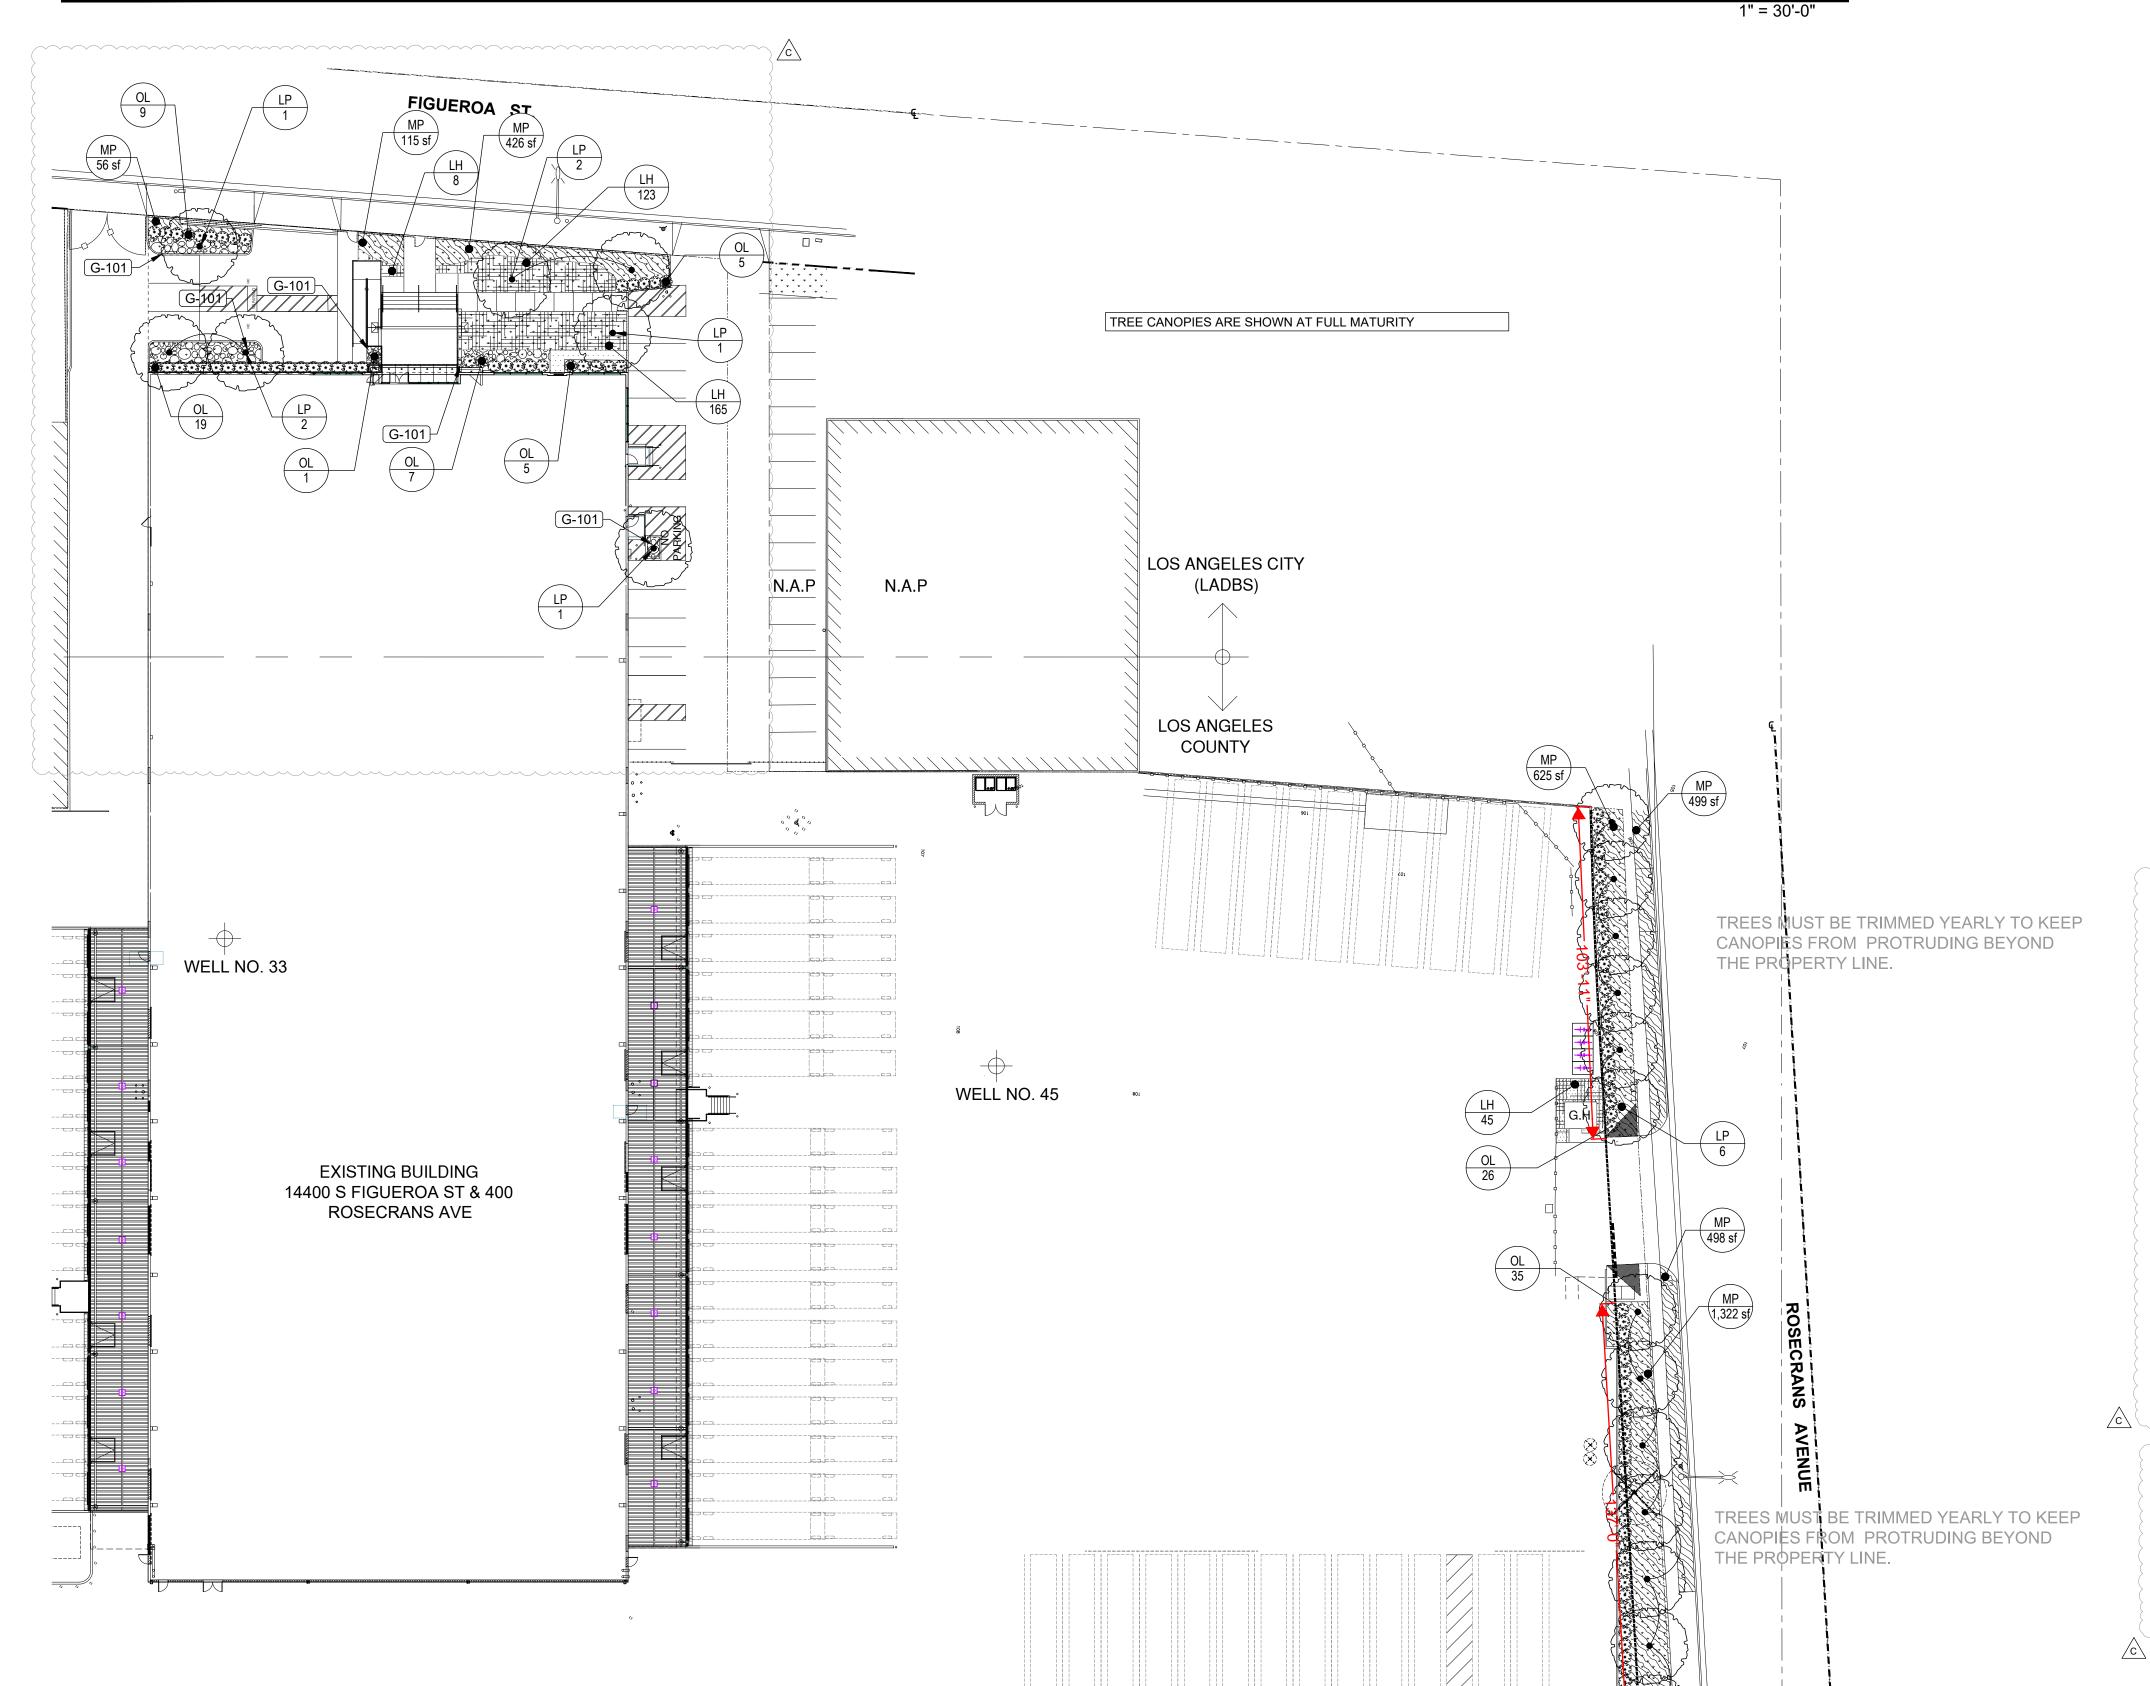

I agree to comply with the requirements of the water efficient landscape ordinance and submit a complete Landscape Documentation Package and I have complied with the criteria of the ordinance and applied them for the efficient use of water in the landscape design plans




	Specie	s Name	Canopy	Canopy	100% Sha	de Credit	75% Shac	le Credit	50% Shad	e Credit	25% Shad	le Credit	Provided
Symbol	Botanical	Common	Diameter	Area	Quantity	Area	Quantity	Area	Quantity	Area	Quantity	Area	Shade Area
	Lagerstroem												
	ia	Crpae Myrtle	25.00	491		0		0	6	1473	0.00	0	1,473
				0		0		0	0	0	0.00	0	-
				0		0		0	0	0		0	-
				0		0		0	0	0		0	-
				0		0		0		0		0	-
				0		0		0		0		0	-
				0		0		0		0		0	-
				0		0		0		0		0	-
Total Pro	ovided Trees:	6			0		0		6		0		
										Total Pro	ovided Sha	de Area :	1,473
								Pe	rcent Shac	le Covera	ge (50% M	inimum):	58%

PLANT SCH	EDULE									
SYMBOL	CODE	QTY	BOTANICAL NAME	COMMON NAME	CONT. SIZE	CAL	SPECS.	<u>HZ</u>	WUCOLS	
TREES	LP	20	Lagerstroemia indica x fauriei `Tuskegee`	Tuskegee Crape Myrtle	24" Box Standard	2"Cal	7` x 2.5`	2	L 0.2 PF	
SYMBOL	CODE	QTY	BOTANICAL NAME	COMMON NAME	CONT. SIZE	SPACING	HZ	WUCOLS		
SHRUBS	OL	107	Olea europaea 'Montra' Setback from paving 24"	Little Ollie® Olive	15 gal	48" oc	1	L 0.2 PF		
SYMBOL	CODE	<u>QTY</u>	BOTANICAL NAME	COMMON NAME	CONT. SIZE	SPACING	HZ	WUCOLS		SPACING
SHRUB AF	REAS LH	1,315 sf	Lantana x `New Gold` Hold bacl from paving and walls 18"	New Gold Lantana	1 gal	24" o.c.	1	L 0.2 PF		24" o.c.
SYMBOL	CODE	QTY	BOTANICAL NAME	COMMON NAME	CONT	SPACING	<u>HZ</u>	WUCOLS		SPACING
GROUND (COVERS MP	75 flats	Myoporum parvifolium `Putah Creek`	Putah Creek Myoporum	Flats	9" oc	1	L 0.2 PF		

NON-LIVING GROUND COVER SCHEDULE	NON-LIVING GROUND COVER SCHEDULE					
SYMBOL DESCRIPTION	QTY					
G-101 Arizona River Rock - 1 1/2 to 3 inch	452 sf					

LANDSCAPE AREA CALCULATIONS	
DESCRIPTION	QTY
Landscape Area	5,168 sf
Required 5' Rosecrans Landscape Buffer	1,196 sf
Total Landscape Area	6,364 sf
Combined Lot Area	291,431

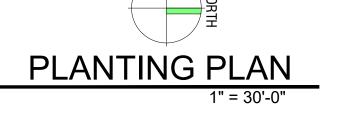

Landscape Percentage



JOB NO. CM220364

SUBMITTAL DATE

CLIENT SUBMITTAL 10/18/23

CLIENT RE-SUBMITTAL 02.21.24

REVISION DATE

c Bid Addendum 'C'. 06.21.24

⊑ LADBS STAMP

architects, any unauthorized reuse of these plans

Rexford Industrial

DA ST.

DUSTRIAL REALTY

GARDENA, CA 90
REXFORD INI
THEXOWILSHIRE BOUL



DESIGN.COM

PLANTING PLAN

SHEET NO. L100

SHEET 2 OF 10

GENERAL PLANTING NOTES

- 1. Installer shall be responsible for making himself familiar with all underground utilities, pipes and structures. Installer shall take sole responsibility for any cost incurred due to damage of said utilities.
- 2. The installer shall make himself familiar with all local, regional, County, State and Federal regulations, requirements etc. in affect as to the transport, import, delivery and installation of all plant materials specified on the plans. It is strongly recommended to source plant materials from local nurseries that are also familiar with the requirements for growing, supplying and transporting plants into the area of the project.
- 3. Installer shall not willfully proceed with construction as designed when it is obvious that unknown obstructions and/or grade differences exist that may not have been known during design.
- 4. Installer shall have soils tested by a qualified agronomy laboratory. Materials and mixing of soil amendments, fertilizers, and back fill for planting pits shall be in accordance with recommendations of the soils agronomy report.
- 5. The installer shall secure all plant material for the project upon award of contract but in no instances less than 120 days prior to installation.
- 6. All plant material shall be approved by the Landscape Architect, Owner or Owner's representative prior to installation.
- 7. Final location of all plant material shall be subject to the approval of the Construction Manager.
- 8. See details for staking method and plant pit dimensions.
- 9. If conflicts arise between size of areas and plans, Installer to contact Construction Manager for resolution. Failure to make such conflicts known to the Construction Manager will result in Installer's liability to relocate the materials.
- 10. All ground covers to be held back 4" from edge of new shrubs typical and 2" from back of curbs or edge of walks at time of planting.
- 11. Ground covers shall be triangularly spaced per detail.
- 12. Trees shall be located minimum 4' from walls, overhead, walks, headers and other trees within the project, unless otherwise shown.
- 13. Place Deep Root Barrier at new trees that are with in 5' of Curbs or paving unless noted otherwise on the plans. Deep Root model UB 24-2 see installation detail.
- 14. Separate all ground cover and shrub areas from lawn areas with headers as per the installation details.
- 15. All slopes greater than 3:1 in shrub areas shall be covered jute mesh to prevent soil erosion during plant establishment
- 16. Remove stakes and trellis from vines and espaliers and secure to walls, fences and posts as per detail
- 17. In all cases "Root Bound" plant material will not be accepted.
- 18. No trees are to be planted within or above site storm drain pipes, swales or retention basins.
- 19. All planting areas including pots irrigated with drip irrigation or low volume irrigation components shall be hand watered by the installer until the plant materials root zones have established enough to effectively access the irrigation water from the drip systems.
- 20. Planting areas (except lawn and hydroseed areas as well as areas of Decomposed Granite) to be top dressed with 3" (thee inch) min, layer of mulch Agromin ES-2 or equal. Agromin (800)247-6646
- 21. Suitable Soil Import
- a. General Topsoil shall be free of roots, clods, stones larger than 1-inch in the greatest dimension, pockets of coarse sand, noxious weeds, sticks, lumber, brush and other litter. It shall not be infested with nematodes or other undesirable disease-causing organisms such as insects and plant pathogens
- b. Topsoil shall be friable and have sufficient structure in order to give good tilth and aeration to the soil.
- c. Gradation limits soil shall be a sandy loam. The definition of soil texture shall be the USDA classification scheme cited below. Gravel over 2 millimeters in diameter shall be less than 20% by weight
- d. Permeability Rate Hydraulic conductivity rate shall be not less than one inch per hour nor more than 10 inches per hour when tested in accordance with the USDA Handbook Number 60, method 34b or other approved methods.
- e. Fertility The range of the essential elemental concentration in soil shall be as follows for approval of source soil:

Ammonium Bicarbonate/DTPA Extraction parts per million (mg/kilogram

dry weigl	nt basis
phosphorus	10 - 40
potassium	100 - 220
iron	5- 35
manganese	0.6 - 6
zinc	1 - 8
copper	0.3 - 5
boron	0.2 - 1
magnesium	50 - 150

sodium sulfur

molybdenum

f. Acidity - The soil pH range measured in the saturation extract (Method 21a, USDA Handbook Number 60) shall be 6.0 - 7.9.

0 - 100

0.1 - 2

25 - 500

- g. Salinity The salinity range measured in the saturation extract (Method 3a, USDA Handbook Number 60) shall be 0.5 2.5 dS/m.
 h. Chloride The maximum concentration of soluble chloride in the saturation extract (Method 3a, USDA Handbook Number 60) shall be
- 150 mg/l (parts per million). Boron - The maximum concentration of soluble boron in the saturation extract (Method 3a, USDA Handbook Number 60) shall be
- 1 mg/l (parts per million). j. Sodium Adsorption Ratio (SAR) - The maximum SAR shall be 3 measured per Method 20b, USDA Handbook Number 60.
- k. Aluminum Available aluminum measured with the Ammonium Bicarbonate/DTPA Extraction shall be less than 3 parts per million.
- I. Soil Organic Matter Content Sufficient soil organic matter shall be present to impart good physical soil properties but not be excessive to cause toxicity or cause excessive reduction in the volume of soil due to decomposition of organic matter. The desirable range is 3% to 5%. The carbon:nitrogen ratio should be about 10.
- m. Calcium Carbonate Content Free calcium carbonate (limestone) shall not be present for acid-loving plants.
- n. Heavy Metals The maximum permissible elemental concentration in the soil shall not exceed the following concentrations:

Ammonium Bicarbonate/DTPA Extraction parts per million (mg/kilogram)

ary weignt	pasis
arsenic	1
cadmium	1
chromium	10
cobalt	2
lead	30
mercury	1
nickel	5
selenium	3
silver	0.5
vanadium	3

o. If the soil pH is between 6 and 7, the maximum permissible elemental concentration shall be reduced 50%. If the soil pH is less than 6.0, the maximum permissible elemental concentration shall be reduced 75%. No more than three metals shall be present at 50% or more of the above values.

Phytotoxic constituent, herbicides, hydrocarbons etc. - Germination and growth of monocots and dicots shall not be restricted more than 10% compared to the reference soil. Growth inhibiting constituents must not be present.

20. Organic soil amendment

- a. Composted aerobic humus compost without presence of decomposition products. The organic matter content shall be at least 50% on dry weight basis. Humus material shall have an acid-soluble ash content of no less than 6% and no more than 20%.
- b. The pH of the material shall be between 6 and 7.5.
- c. The salt content shall be less than 6 millimho/cm @ 25° C. (ECe less than 6) in a saturated paste extract.
- d. Boron content of the saturated extract shall be less than 1.0 part per million.

 Silicon content (acid-insoluble ash) shall be less than 50%
- e. Silicon content (acid-insoluble ash) shall be less than 50%.f. Calcium carbonate shall not be present if to be applied on alkaline soils.
- g. Types of acceptable products are composts, manures, mushroom composts, straw, alfalfa, peat mosses etc. low in salts, low in heavy
- metals, free from weed seeds, free of pathogens and other deleterious materials.

 h. Composted wood products are conditionally acceptable [stable humus must be present]. Wood based products are not acceptable
- which are based on red wood or cedar.i. Sludge-based materials are not acceptable.
- j. Carbon:nitrogen ratio is between 8.0 and 20:1.k. SAR (sodium adsorption ratio) less than 5.

- I. Seed germination over 80% germination in saturation extract diluted 1 to 3 in water compared to seeds germinated in deionized
- m. Germination vigor equal to or better than seed length for seeds germinated in deionized water.
- n. Maturity and stability Solvita 5 or higher.
- o. Molar ratio of ammoniacal nitrogen to nitrate nitrogen less than 2.
- p. The compost shall be aerobic without malodorous presence of decomposition products. q. The maximum particle size shall be 0.5 inch, 80% or more shall pass a No. 4 screen.
 - Maximum total permissible pollutant concentrations in amendment in parts per million on a dry weight basis:

arsenic	12	copper	100	selenium	20
cadmium	15	lead	100	silver	10
chromium	100	mercury	10	vanadium	50
cobalt	50	zinc	200	molybdenum	20
nickel	100			•	

- 20. Decomposed granite (D.G.) install a 2" (Min.) layer of Decomposed Granite w/ stabilizer continuous, color as per plan, in all planters under all trees and shrubs as indicated. Before placing granite, compact sub-grade to 85% and apply a pre-emergent herbicide to soil. After placing granite: rake smooth, wet to entire depth, allow to dry, then lightly scarify surface with a leaf rake. Apply a secondary application of pre-emergent herbicide to top of granite. Keep top of granite 1" below adjacent walks and curbs. Do not allow granite to touch the trunk of any plant. Install after installation of plant material making note of plant height so they are not buried by D.G..
- 21. Cactus / Succulent Mix:

Pumice or Perlite (Approximately 40%)
Potting Soil Mix (Approximately 15%)
Clean Washed River Sand (Approximately 10%)
Loosened Coir (Approximately 35%)

- 22. All Washingtonia Palms shall be skinned to the green fronds above and shall be as per the brown trunk height (BT) as indicated on the planting plan and legend.
- 23. All Phoenix Palms shall be "Pineapple Cut" skinned and shall be as per the brown trunk height (BT) as indicated on the planting plan and legend and matched to be of equal height in each area of use.
- 24. Brown Trunk Height "BT" shall mean as measured from the ground line to the base of the heart leaf.
- 25. All Palms must be certified disease and pest free by a licensed Arborist. Written documentation must be provided prior to planting.

SOIL TESTS FOR SOIL MANAGEMENT

- 1. The Contractor shall be responsible for obtaining soils testing and soil amendment recommendations. Soils testing shall be completed and test results and amendment recommendations submitted to the Owner's Representative a minimum of sixty (60) days before commencement of any planting. The report shall be reviewed approved by the project Landscape Architect and ALL required governing agencies PRIOR to the commencement of any soil amending or planting.
- 2. The testing laboratory shall be WALLACE LABORATORIES, LLC 365 Coral Circle El Segundo, CA 90245 phone (310) 615-0116 or approved equal as approved by the Owner's Representative., or approved equal as approved by the Owner's Representative.
- 3. The testing laboratory for soils analysis shall use the following criteria for soil testing: USDA Agricultural Suitability Test per Handbook 60, to include Boron presence and content; and University of California Soil Fertility Test.
- 4. Interpretations, fertilization and soil amendment recommendations, and comments regarding these tests are required.
- 5. Infiltration Rate determined by laboratory test or Soil Texture and Infiltration Rate table
- 6. Soils test sites shall occur not more than 250 feet on center in the planting areas, unless otherwise noted on plans.
- 7. Samples of all import soil from each source shall also be submitted to the soils testing laboratory for analysis, interpretation and recommendations prior to placement, blending or back-filling.
- 8. A copy of the plant schedule shall be provided to the lab for review and comment in relation to the results of the soils tests.

PERCOLATION TEST


1. The landscape installer shall dig (as test areas) four (4) plant pits of 24" box size, or larger, at four (4) locations minimum within the job site. Pits are to be filled with water. The results of this test shall be reported to the Landscape Architect and owner 48 hours after initiating. Test pits shall be in actual location of trees as shown on the plan. Failure to carry out this test shall make the landscape installer liable for any and all trees that die due to poor water percolation beyond the agreed guarantee period.

OPTION 1

Should the water drain out of the test pits at a normal rate indicating good percolation then tree detail "A" and shrub planting detail "A" shall be utilized.

OPTION 2

In the event any amount of water is left standing in the test pit (per the above procedure) 24 hours after initiating the percolation test then the vertical mulching details for tree detail "B" and shrub detail "B" shall apply to all trees and shrubs regardless of size. These details shall supersede all other planting details. However, the tree staking requirements of tree planting detail "A" shall remain intact in either case.

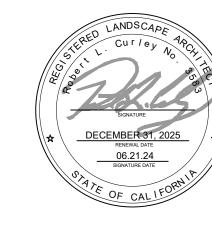

JOB NO. CM220364

SUBMITTAL DATE

CLIENT SUBMITTAL 10/18/23

CLIENT RE-SUBMITTAL 02.21.24

REVISION DATE

Object

Object

Object

Description:

Description:

Object

Description:

Object

Description:

Object

Object

Object

Description:

Object

Description:

Object

Description:

Object

Description:

Object

Object

Description:

Object

Description

LADBS STAMP

ซี CLIENT:

RE

TR

R E

Rexford Industrial

OD S FIGUEROA ST.

RDENA, CA 90248

XFORD INDUSTRIAL REAL

SO WILSHIRE BOULEVARD, Suite 610

ANGELES, CA 90024

CUMMINGS CURLEY AND ASSOCIATES, IN AND ASSOCIATES, IN EARL BEACH, CALIFORNIA 90740
TEL. 562.424.8182

CALIFORNIA 3583 • ARIZONA 30100 • NEVADA 578 • UTAH 377204
COLORADO 1559 • TEXAS 3337 • WASHINGTON 1069 • CLARB 1848



PLANTING NOTES

SHEET NO. L101


ກ໌ ———— ໜ້ 06/21/24

SHEET 3 OF 10

NUMBER	MODEL	SIZE	TYPE	<u>GPM</u>	DESIGN PSI	FRICTION LOSS	VALVE LOSS	<u>PSI</u>	PSI @ POC	PRECIP
A-1	Rain Bird XCZ-100-PRB-COM	1"	Area for Dripline	5.41	20	0.63	7.41	28.0	40.6	0.84 in/h
A-2	Rain Bird PEB	1"	Bubbler	7	20	1.57	1.74	23.3	36.9	1.71 in/h
A-3	Rain Bird XCZ-100-PRB-COM	1"	Area for Dripline	10.78	20	1.05	13.6	34.6	52.4	0.68 in/h

VALVE SCH	HEDULE									
NUMBER	MODEL	SIZE	TYPE	GPM	DESIGN PSI	FRICTION LOSS	VALVE LOSS	PSI	PSI @ POC	PRE
B1-1	Rain Bird XCZ-100-PRB-COM	1"	Area for Dripline	7.52	20	0.46	9.52	30.0	43.7	0.69 i
B1-2	Rain Bird XCZ-100-PRB-COM	1"	Area for Dripline	7.23	20	1.52	9.23	30.7	44.3	0.7 in
B2-1	Rain Bird PEB	1"	Bubbler	13	20	3.22	2.13	25.4	44.5	1.7 in
B2-2	Rain Bird XCZ-100-PRB-COM	1"	Area for Dripline	10.59	20	0.28	13.2	33.5	50.4	0.53 i

I agree to comply with the requirements of the water
efficient landscape ordinance and submit a complete
Landscape Documentation Package and I have
complied with the criteria of the ordinance and applied
them for the efficient use of water in the landscape
decian nlane

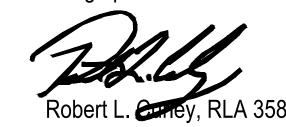


	0004.00.40.40.50
Generated:	2024-06-19 12:50
P.O.C. NUMBER: 03	
Water Source Information:	Stub off building domestic line before any backflow preventers. Pressure estimated.
FLOW AVAILABLE	
Point of Connection Size:	1 1/2"
Flow Available	40.32 GPM
PRESSURE AVAILABLE	
Static Pressure at POC:	70 PSI
Pressure Available:	70 PSI
DESIGN ANALYSIS	
Maximum Station Flow:	10.78 GPM
Flow Available at POC:	40.32 GPM
Residual Flow Available:	29.54 GPM
Critical Station:	A-3
Design Pressure:	20 PSI
Friction Loss:	0.95 PSI
Fittings Loss:	0.1 PSI
Elevation Loss:	0 PSI
Loss through Valve:	13.6 PSI
Pressure Req. at Critical Station:	34.6 PSI
Loss for Fittings:	0 PSI
Loss for Main Line:	6.14 PSI
Loss for POC to Valve Elevation:	0 PSI
Loss for Backflow:	11.6 PSI
Critical Station Pressure at POC:	52.4 PSI
	70 PSI
Pressure Available: Residual Pressure Available:	

CRITICAL ANALYSIS	
Generated:	2023-10-25 07:00
P.O.C. NUMBER: 01	
Water Source Information:	Existing Domestic Meter. 50/110 Per Golden State Wa
For irrigation use only	•
FLOW AVAILABLE	
Water Meter Size:	1"
Flow Available	18.2 GPM
PRESSURE AVAILABLE	
Static Pressure at POC:	75 PSI
Elevation Change:	0.00 ft
Service Line Size:	1"
Length of Service Line:	20 ft
Pressure Available:	73 PSI
DESIGN ANALYSIS Maximum Station Flow:	12 GPM
Flow Available at POC:	18.2 GPM
Residual Flow Available:	6.2 GPM
Critical Station:	B-3
Design Pressure:	30 PSI
Friction Loss:	0.25 PSI
Fittings Loss:	0.03 PSI
Elevation Loss:	0 PSI
Loss through Valve:	13.2 PSI
Pressure Req. at Critical Station:	38.3 PSI
Loss for Fittings:	0 PSI
Loss for Main Line:	4.52 PSI
Loss for POC to Valve Elevation:	0 PSI
Loss for Backflow:	11.6 PSI
Loss for Water Meter:	0.76 PSI
Critical Station Pressure at POC:	55.2 PSI
D	73 PSI
Pressure Available: Residual Pressure Available:	10101

FIGUEROA ST. 5.41 A-1 T T A-2 T T T T T T T T T T T T T T T T T T T	3/4"	LOS ANGELES CITY (LADBS)	
EXISTING BUILDING 14400 S FIGUEROA ST & 400 ROSECRANS AVE		H2 SC IRRIGATION WITH WEAT SC WIRELESS WEAT	DLAR POWERED N CONTROLLER THER STATION. 10.6 B2-2 H1 1" DLAR POWERED
	°°°°°°°°°°°°°°°°°°°°°°°°°°°°°°°°°°°°°°		

SYMBOL	MANUFACTURER/MODEL/DESCRIPTION	QTY	ARC	PSI	GPM	RADIUS
	Rain Bird RWS-B-C 1402					
•	Root Watering System with 4.0" diameter x 36.0" long with locking	40	360	20	0.5	3'
•	grate, semi-rigid mesh tube, and check valve. Rain Bird bubbler option as indicated: 1401 0.25 GPM, 1402 0.5 GPM, 1404 1.0	10	000	20	0.0	· ·
	GPM, 1408 2.0 GPM.					
SYMBOL	MANUFACTURER/MODEL/DESCRIPTION	QTY		PSI		
	Rain Bird XCZ-100-PRB-COM					
	Wide Flow Drip Control Kit for Commercial Applications. 1" Ball	5				
	Valve with 1" PESB Valve and 1" Pressure Regulating 40psi Quick-Check Basket Filter. 0.3 GPM-20 GPM					
F	Netafim TLFV-1	13				
Ŷ	Automatic Flush Valve, with Insert Inlet					
A	Netafim TLAVRV Air/Vacuum relief valve, 1/2" male pipe thread.	8				
	Area to Receive Dripline					
	Rain Bird XFS-06-18					
	XFS Sub-Surface Pressure Compensating Dripline w/Copper Shield Technology. 0.6 GPH emitters at 18" O.C. Laterals spaced	6,575 s.f.		20		
	at 18" apart, with emitters offset for triangular pattern. UV					
	Resistant. Specify XF insert fittings.					
SYMBOL	MANUFACTURER/MODEL/DESCRIPTION	QTY				
•	Rain Bird PEB 1", 1-1/2", 2" Plastic Industrial Valves. Low Flow Operating	2				
•	Capability, Globe Configuration.					
_	Rain Bird 33-DRC					
	3/4" Brass Quick-Coupling Valve, with Corrosion-Resistant Stainless Steel Spring, Thermoplastic Rubber Cover, Double	3				
	Track Key Lug, and 2-Piece Body.					
X 1	Nibco T-FP600A-LF	3				
	Lead-Free Brass, Two-Piece, Full Port, NPT x NPT					
	Zurn 975XL 1" Reduced Pressure Backflow device. Mount in Strong Box	1				
	SBBC-22CR enclosure. Plumb with " pressure reducing valve 500XL set at 50 PSI					
	Zurn 975XL 1"	4				
	Reduced Pressure Backflow device. Mount in Strong Box SBBC-22CR enclosure. Plumb with " pressure reducing valve	1				
	500XL set at 50 PSI					
B1	DIG Corporation LEIT-2ET	1				
	Two Station, Weather Based, Ambient Light (Solar) Powered, Wireless Irrigation Controller.					
	DIG Corporation LEIT-2ET					
B2	Two Station, Weather Based, Ambient Light (Solar) Powered,	1				
	Wireless Irrigation Controller.					
W1	DIG Corporation LEIT-2ET Two Station, Weather Based, Ambient Light (Solar) Powered,	1				
	Wireless Irrigation Controller.					
W2	DIG Corporation LEIT-2ET	1				
<u></u>	Two Station, Weather Based, Ambient Light (Solar) Powered, Wireless Irrigation Controller.	•				
_	Hunter HC-6	4				
	6 station controller with Wi-Fi connection. Mount in Strong Box	1				
	LD-16S enclosure					
⟨W ⟩	Hunter MINI-CLIK SG-MC Rain Sensor, with stainless steel Sensor Guard protection, mount	1				
	as noted					
	Water Meter 1" Existing Domestic Meter. 50/110 Per Golden State Water.	1				
_	For irrigation use only					
POC	Point of Connection 1 1/2"	1				
±	Stub off building domestic line before any backflow preventers. Pressure estimated.					
	- Irrigation Lateral Line: PVC Schedule 40	948.3 l.f.				
	Imigration Mainlines DVO O. L. J. J. 40	500 C : -				
	- Irrigation Mainline: PVC Schedule 40	536.8 l.f.				
	Pipe Sleeve: PVC Class 200					
	Typical pipe sleeve for irrigation pipe. Pipe sleeve size shall allow	229.8 l.f.				
	for irrigation piping and their related couplings to easily slide through sleeving material. Extend sleeves 18 inches beyond					
	edges of paving or construction.					
	Valve Callout Valve Number					
#• #•	Valve Flow					
\ #"∙∕	Valve Size					



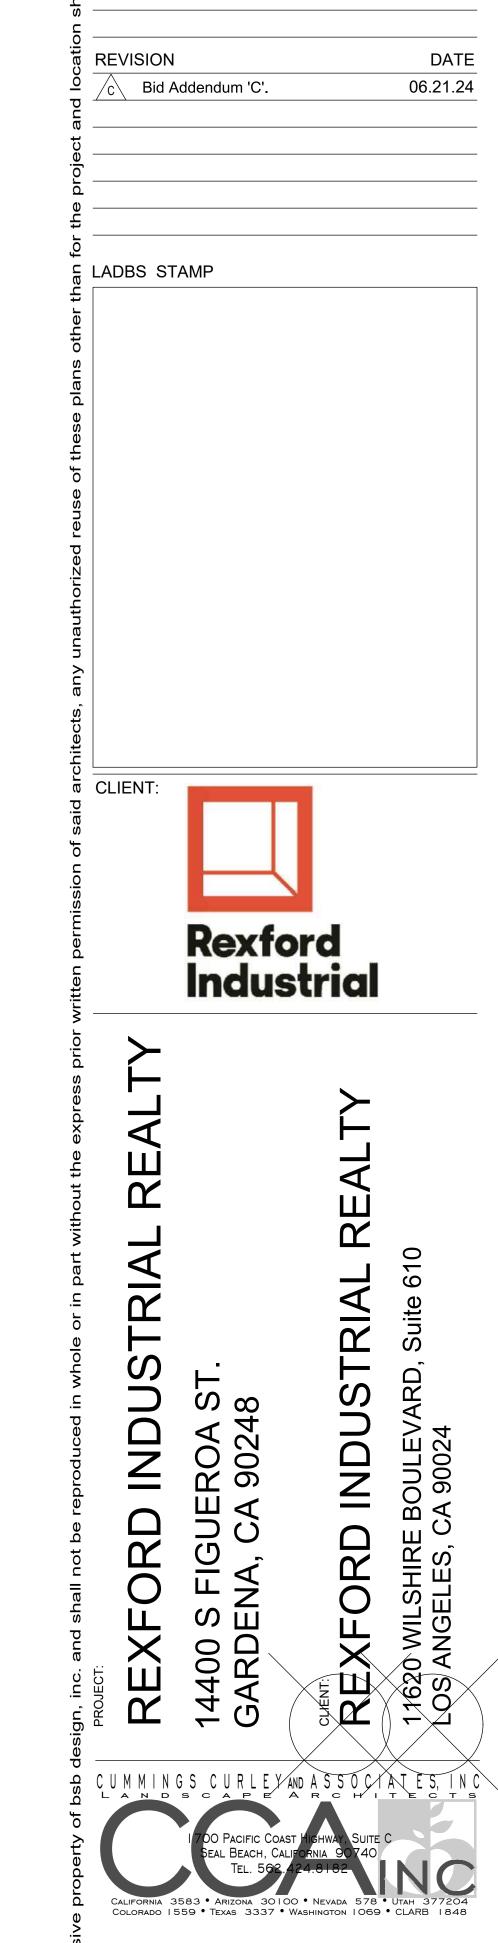

CM220364

DATE

10/18/23

02.21.24

JOB NO.

SUBMITTAL

CLIENT SUBMITTAL

CLIENT RE-SUBMITTAL



SHEET TITLE

IRRIGATION PLAN

SHEET NO. L200

SHEET 4 OF 10

14440 FIGUEROA STREET

WATER EFFICIENT LANDSCAPE WORKSHEET

This worksheet is filled out by the project applicant and it is a required element of the Landscape Documentation Package.

Hydrozone # /Planting Description ^a	Plant Factor (PF)	Irrigation Method ^b	Irrigation Efficiency (IE) ^c	ETAF (PF/IE)	Landscape Area (sq, ft,)	ETAF x Area	Estimated Tota Water Use (ETWU)°
Regular Landscap	e Areas						
SHRUBS / GRUND COVER	0.20	DRIP	.85	0.24	3,037.71	750.05	18,461.78
TREES	0.20	CRIP	.80	.025	226.08	55.82	1,374.01
				Totals	3,264 ^{A)}	805.69	19,836
Special Landscap	e Areas			•	•		
				1			
				1			
				1			
				Totals	(C)	(D)	
				1		ETWU Total	19,836
	Maximum Allowed Water Allowance (MAWA) ^e						

^bIrrigation Method ^cIrrigation Efficiency ^dETWU (Annual Gallons Required) = ^aHydrozone #/Planting Description overhead spray 0.75 for spray head Eto x 0.62 x ETAF x Area E.g 1.) front lawn 2.) low water use plantings 3.) medium water use planting gallons per square foot per

^eMAWA (Annual Gallons Allowed) = (Eto) (0.62) [(ETAF x LA) + ((1-ETAF) x SLA)] where 0.62 is a conversion factor that converts acre-

inches per acre per year to gallons per square foot per year, LA is the total landscape area in square feet, SLA is the total special landscape area in square feet, and ETAF is .55 for residential areas and 0.45 for non-

ETAF Calculations

Regular Landscane A

Average ETAF	B÷A	0.24
Total Area	(A)	3,264
Total ETAF x Area	(B)	805.87
Regular Landscape Areas		

Average ETAF for Regular Landscape Areas must be 0.55 or below for residential areas, and 0.45 or below for non-residential areas.

where 0.62 is a conversion

inches per acre per year to

factor that converts acre-

All Landscape Areas

		, ,	3,204
	Total Area	(A+C)	3,264
L	Total ETAF x Area	(B+D)	805.87

A copy of this form may be obtained from Department of Water Resources website: http://www.water.ca.gov/wateruseefficiency/landscapeordinance/

ROSECRANS AVENUE

WATER EFFICIENT LANDSCAPE WORKSHEET

This worksheet is filled out by the project applicant and it is a required element of the Landscape Documentation Package.

Hydrozone # /Planting Description ^a	Plant Factor (PF)	Irrigation Method ^b	Irrigation Efficiency (IE)°	ETAF (PF/IE)	Landscape Area (sq, ft,)	ETAF x Area	Estimated Tota Water Use (ETWU) ^e
Regular Landscap	e Areas						
SHRUBS / GRUND COVER	0.20	DRIP	.85	0.24	3780.53	889.54	21,895.05
TREES	0.20	CRIP	.80	.025	339.12	87.74	2,086.77
				Totals	4,126 ^{A)}	974.5	23,982
Special Landscape	e Areas						
				1			
				1			
				1			
				Totals	(C)	(D)	
				1		ETWU Total	23,982
-			Maxi	mum Allowe	d Water Allowa	nce (MAWA)e	46,664

^bIrrigation Method ^dETWU (Annual Gallons Required) = ^aHydrozone #/Planting Description ^cIrrigation Efficiency overhead spray 0.75 for spray head Eto x 0.62 x ETAF x Area 1.) front lawn where 0.62 is a conversion 2.) low water use plantings factor that converts acre-3.) medium water use planting inches per acre per year to gallons per square foot per ^eMAWA (Annual Gallons Allowed) = (Eto) (0.62) [(ETAF x LA)

+ ((1-ETAF) x SLA)] where 0.62 is a conversion factor that converts acreinches per acre per year to gallons per square foot per year, LA is the total landscape area in square feet, SLA is the total special landscape area in square feet, and ETAF is .55 for residential areas and 0.45 for non-

ETAF Calculations

Regular Landscape Areas

residential areas.

. то долог — оптого розгионо		
Total ETAF x Area	(B)	974.32
Total Area	(A)	4,120
Average ETAF	B÷A	0.24

Average ETAF for Regular Landscape Areas must be 0.55 or below for residential areas, and 0.45 or below for non-residential areas.

All Landscape Areas

Sitewide ETAF	(B+D) ÷ (A+C)	0.24
Total Area	(A+C)	4,120
Total ETAF x Area	(B+D)	974.32

A copy of this form may be obtained from Department of Water Resources website: http://www.water.ca.gov/wateruseefficiency/landscapeordinance/

IRRIGATION NOTES

VERIFICATION:

The system is based on a static 50 / 110 p.s.i. and 22 g.p.m. available at the discharge outlet of the meter or other point of connection. The contractor shall verify the same at the award of the contract. The contractor shall notify the Landscape Architect immediately if the data is significantly different and would adversely affect the operation of the system. Such notice shall be in writing and shall occur within 5 days of contract award for projects anticipated to take two weeks or longer or 72 hours prior to commencement.

SCHEMATIC:

The system features are shown schematically for graphic clarity: install all piping and valves in common trenches (the minimum cover noted in the legend is required for the upper most line) where feasible and inside planting areas. Valves and main lines shall be located in planter

CODES:

The irrigation system and all other mechanical, electrical, and structural systems shall be installed in accordance with all federal, state, and local codes and manufacture specifications recommendations and requirements. Notify the Landscape Architect immediately in writing prior to signing a contract with the owner of any conflicts. Conflicts noted after signing or after the commencement of work shall be the sole responsibility of the contractor.

HEAD ALLOWANCE: The contractor is required to provide the owner with a complete project. He/she shall install any additional heads, nozzle changes, valves, irrigation lines, wire, etc. as necessary to accommodate any necessary field changes. The contractor shall make all needed changes as

directed by the Landscape Architect and provide the owner with a complete project at no additional cost to the owner.

CHECK VALVES:

Install check valves at the base of any heads that display low end drainage. These shall be included in the contractors price and shall be added as directed by the Landscape Architect and provide the owner with a complete project with no additional cost to the owner.

The contractor shall be responsible for providing adequately sized sleeving for all irrigation pipes, landscape lighting and other components. The drawings are intended to be used as a guide only. Sleeves shall be clearly marked during construction and shall occur under all paved areas and shall extend 1' minimum beyond all paving. Sleeves must be 2x the diameter of pipe running through it.

GUARANTEE:

The contractor shall guarantee the irrigation system and all its components for the period of one year after final acceptance by the Landscape Architect. The contractor shall be responsible for all materials and labor associated with the guarantee, including but not limited to the loss of plant material or damage to structures due to the failure of the irrigation system.

ELECTRICAL SERVICE: All exposed 110V wires shall be placed in rigid metal conduit and hard wired directly to 110V service. All exposed low voltage wire for irrigation and lighting shall also be placed in rigid metal conduit.

VALVE BOXES: Unless specifically noted valves boxes shall be installed in the following colors by area of landscape.

Green box and lid Green box and lid Spreading ground covers: Bark Mulch: Black box and lid Black box and lid Shrub area: Decomposed Granite: Brown box and lid Cobble / Gravel: Black box and lid

Perimeter dripline pipe shall be installed 2"-4" from perimeter area per the detail then spaced per the notations in the Irrigation Schedule. Drip line spacing shall begin at 2"-4" from edge of paving, back of curb and or areas of other materials etc. unless otherwise noted.

PLANT ESTABLISHMENT WITH DRIP IRRIGATION:

All planting areas including pots irrigated with drip irrigation or low volume irrigation components shall be hand watered by the installer until the plant materials root zones have established enough to effectively access the irrigation water from the drip systems.

MAINLINE SIZING:

Mainline shall be sized as follows, based on maximum GPM demand:

0-10 GPM: 1" Schedule 40 PVC Pipe 10-18 GPM: 1-1/4" Schedule 40 PVC Pipe 18-26 GPM: 1-1/2" Schedule 40 PVC Pipe

26-40 GPM: 2" Class 315 PVC Pipe 40-60 GPM: 2 1/2" Class 315 PVC Pipe

60-95 GPM: 3" Class 315 PVC Pipe

JOB NO. CM220364 SUBMITTAL DATE CLIENT SUBMITTAL 10/18/23 **CLIENT RE-SUBMITTAL** 02.21.24

DATE REVISION 06.21.24 Bid Addendum 'C'.

LADBS STAMP


ัติ CLIENT:

TRIAL



RE,

RIAL INDUS လ ထု 11620 WILSHIRE I LOS ANGELES, C

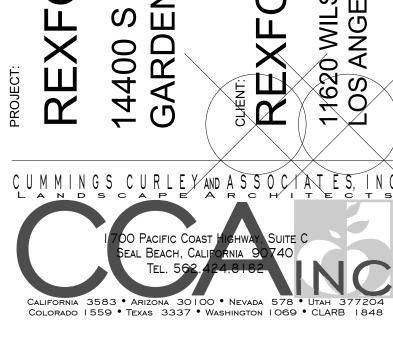





EIRRIGATION NOTES

L201

06/21/24

SHEET 5 OF 10

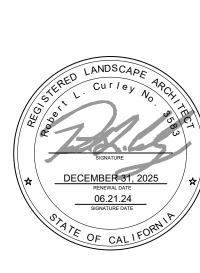

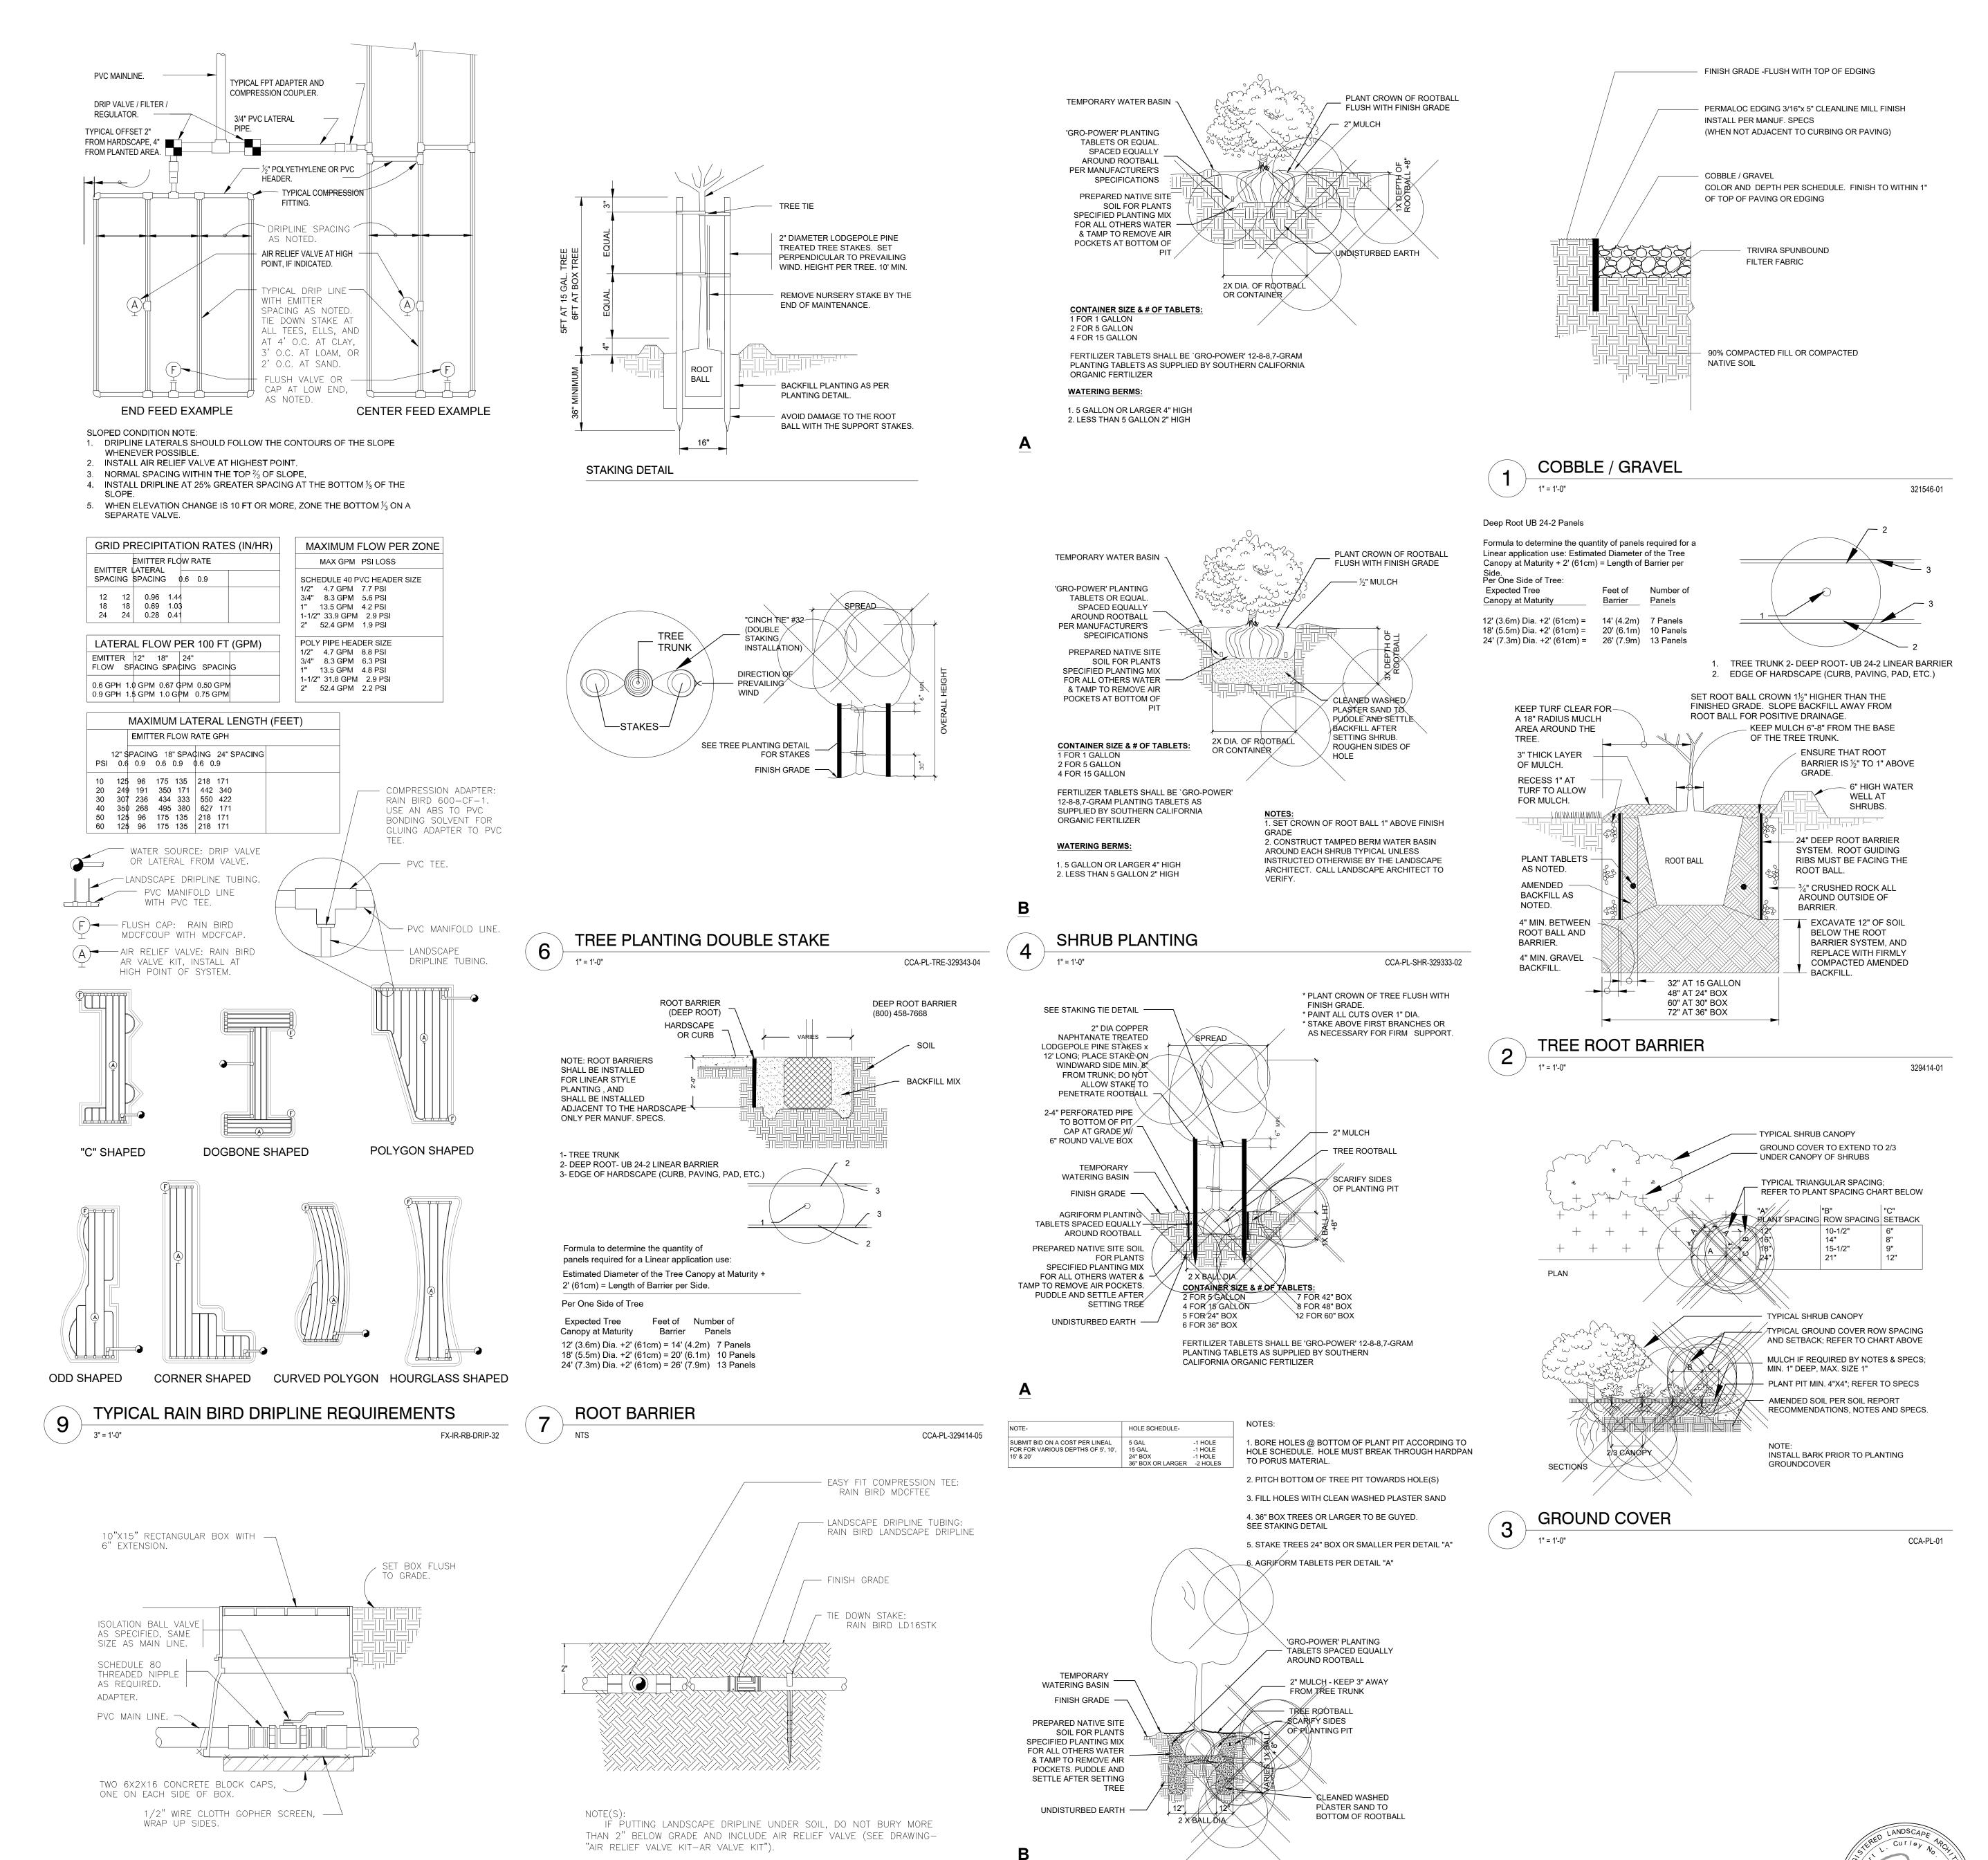

TREE PLANTING

CCA-PL-TRE-329343-02

CCA-IRR-03

BRASS BALL ISOLATION VALVE

DRIPLINE BELOW GRADE

FX-IR-FX-ISOV-02


CM220364 JOB NO. DATE SUBMITTAL CLIENT SUBMITTAL 10/18/23 **CLIENT RE-SUBMITTAL** 02.21.24 DATE REVISION 06.21.24 Bid Addendum 'C'. LADBS STAMP ัติ CLIENT: Rexford Industrial DESIGN **BSBDESIGN.COM** SHEET TITLE LANDSCAPE DETAILS


SHEET NO.


06/21/24

L300

SHEET 6 OF 10

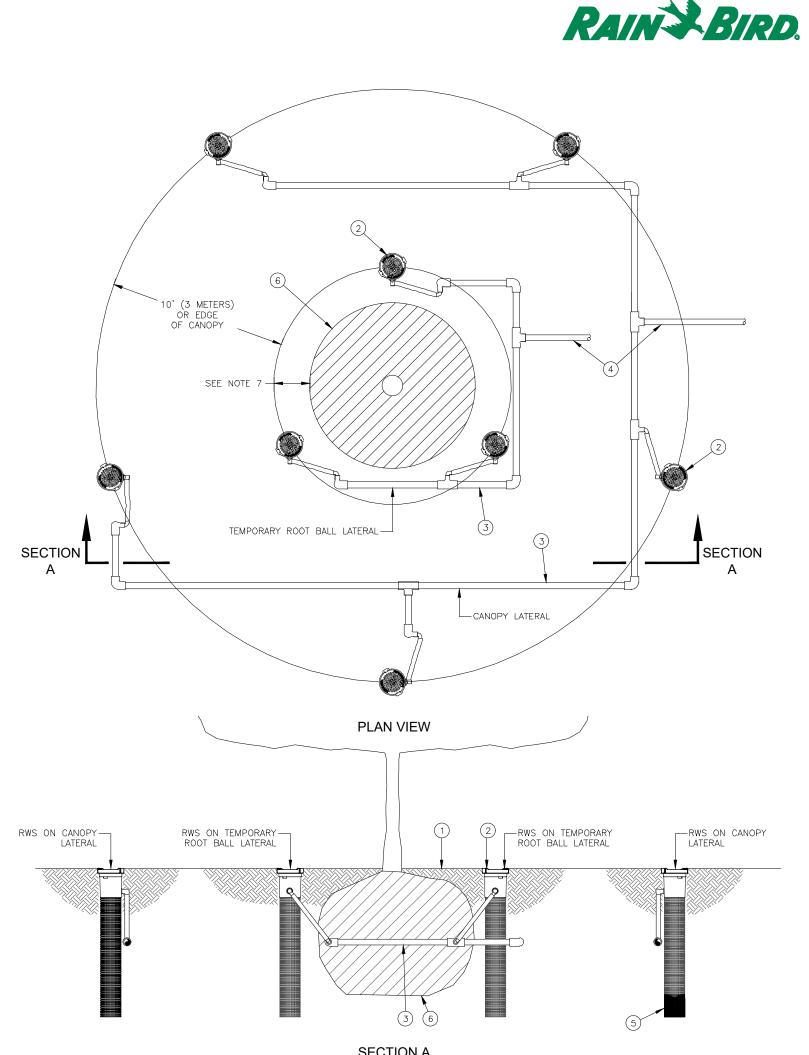

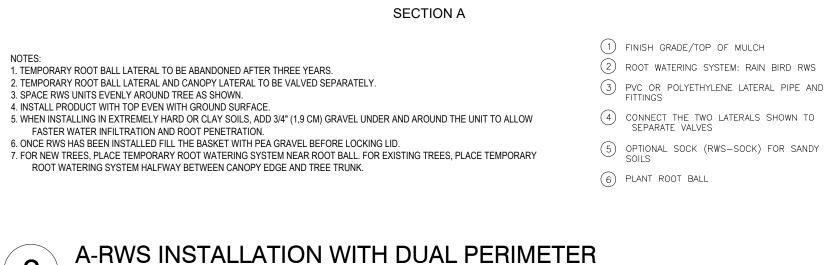

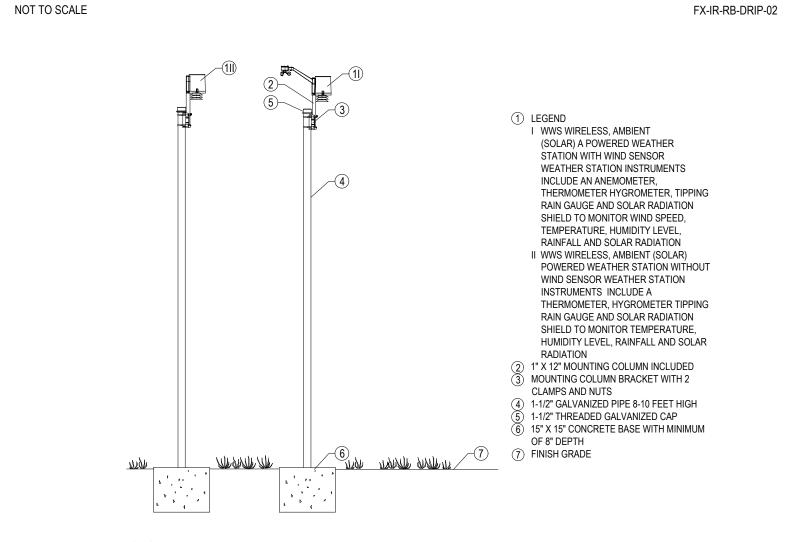

NOTES:


1. INSTALLATION TO BE COMPLETED IN ACCORDANCE WITH MANUFACTURER'S SPECIFICATIONS.

2. DO NOT SCALE DRAWING.

3. THIS DRAWING IS INTENDED FOR USE BY ARCHITECTS, ENGINEERS, CONTRACTORS, CONSULTANTS AND DESIGN PROFESSIONALS FOR PLANNING PURPOSES ONLY. THIS DRAWING MAY NOT BE USED FOR CONSTRUCTION.

4. ALL INFORMATION CONTAINED HEREIN WAS CURRENT AT THE TIME OF DEVELOPMENT BUT MUST BE REVIEWED AND APPROVED BY THE PRODUCT MANUFACTURER TO BE CONSIDERED ACCURATE.

5. CONTRACTOR'S NOTE: FOR PRODUCT AND COMPANY INFORMATION VISIT www.CADdetails.com/info AND ENTER REFERENCE NUMBER

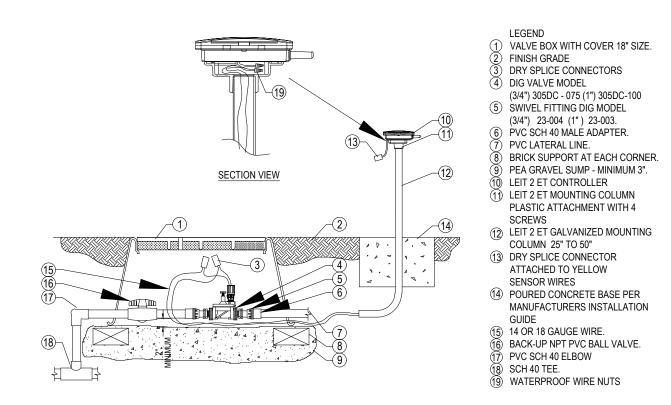

NOTES:

1. INSTALLATION TO BE COMPLETED IN ACCORDANCE WITH MANUFACTURER'S SPECIFICATIONS.

2. DO NOT SCALE DRAWING.


3. THIS DRAWING IS INTENDED FOR USE BY ARCHITECTS, ENGINEERS, CONTRACTORS, CONSULTANTS AND DESIGN PROFESSIONALS FOR PLANNING PURPOSES ONLY. THIS DRAWING MAY NOT BE USED FOR CONSTRUCTION.

4. ALL INFORMATION CONTAINED HEREIN WAS CURRENT AT THE TIME OF DEVELOPMENT BUT MUST BE REVIEWED AND APPROVED BY THE PRODUCT MANUFACTURER TO BE CONSIDERED ACCURATE.

5. CONTRACTOR'S NOTE: FOR PRODUCT AND COMPANY INFORMATION VISIT www.CADdetails.com/info AND ENTER REFERENCE NI IMBER

LEIT-2ET WEATHER BASED, WIRELESS CONTROL

328409.16-01

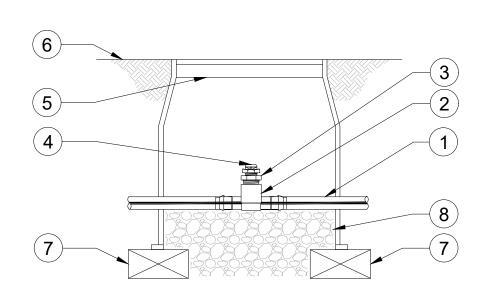

1 LANDSCAPE PRODUCTS 17MM EZ-10 CV COLOR CODED DRIPLINE

(2) LANDSCAPE PRODUCTS 17MM DRIPLINE TEE ADAPTER
(3) 3/4" x 1/2" REDUCER BUSHING

4 LANDSCAPE PRODUCTS 12001240 1/2" AIR RELIEF VALVE


5 LANDSCAPE PRODUCTS 12001690 6" x 9" ROUND EMITTER BOX

6 FINISH GRADE

(7) BRICK FOR SUPPORT
(8) 3" MINIMUM DEPTH OF 3/4" WASHED GRAVEL

NOTES:

1. AIR RELIEF VALVE TO BE INSTALLED AT HIGH POINTS ON THE DRIPLINE.

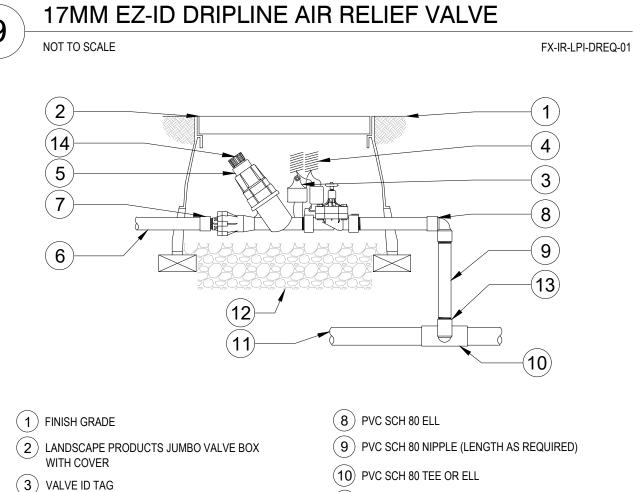


4 30-INCH LENGTH OF COILED WIRE


5 LANDSCAPE PRODUCTS DRIP KIT
(INCLUDES VALVE, FILTER & PRESSURE
REGULATOR)


6 PVC SUPPLY HEADER TO DRIPLINE

7 PVC SCH 80 FEMALE ADAPTER OR REDUCER

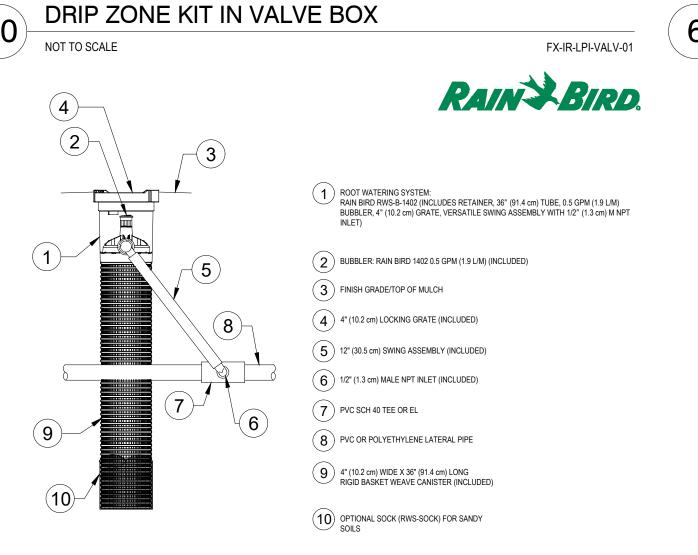

NOTES:
1. 4" (10.2 cm) GRATE IS ALSO AVAILABLE IN PURPLE (RWS-GRATE-P).
2. INSTALL PRODUCT SO THAT THE GRATE IS EVEN WITH FINISH GRADE OR TOP OF MULCH.
3. OPTIONAL SAND SOCK (RWS-SOCK) IS 34" (86.4 cm) IN LENGTH TO COVER MESH BASKET AREA.
4. WHEN INSTALLING IN EXTREMELY HARD OR CLAY SOILS, ADD 3/4" (1.9 cm) GRAVEL UNDER AND AROUND THE UNIT TO ALLOW FASTER WATER INFILTRATION AND ROOT PENETRATION.
5. ONCE RWS HAS BEEN INSTALLED FILL THE BASKET WITH PEA GRAVEL BEFORE LOCKING LID.

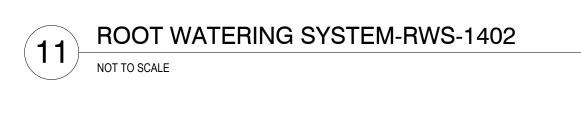

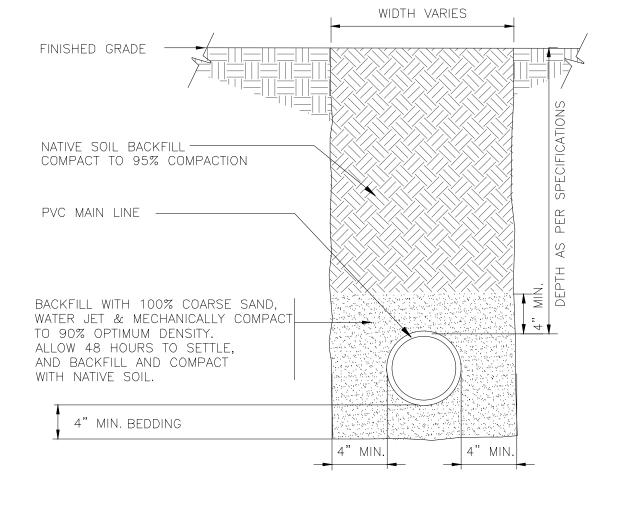

BACKFLOW CAGE (SEE IRRIGATION LEGEND

— 'Y' STRAINER (OPTIONAL SEE SCHEDULE)

PREVENTER WITH BALL VALVES

REDUCED PRESSURE BACKFLOW

BRASS UNION OR FLANGES

PRESSURE

REGULATOR

SEE SCHEDULE)

CONCRETE THRUST BLOCK

FX-IR-FX-BACK-04

(OPTIONAL

MIN. 1 CUBIC FOOT

MINIMUM 24"X24"X24" GRAVEL SUMP

-SL SERIES CONTROLLER (SEE LEGEND FOR MODEL)

SL-AIRCARD RJII CABLE

-SL-AIRCARD MOUNTED TO

-INSTALL SLCSPLICE KIT OR

WATERPROOF CONNECTOR

-DIRECT BURY WIRE TO FLOW

-TO MASTER VALVE (OPTIONAL)

328409.13-01

-VALVE CONTROL WIRES

SENSOR

FINISH GRADE

(ONE PER VALVE)

UNDER ALL DISCHARGE POINTS

PRESSURE SUPPLY LINE FROM WATER SOURCE

FOR MAKE AND MODEL)

(SEE SCHEDULE)

30" MAX.

SLW WEATHER STATION (SEE LEGEND FOR MODEL)

SYNCHRONIZE TO WEATHER

STATION HUB IN CONTROLLER

REDUCED PRESSURE BACKFLOW

WALL

SMARTLINE CONTROLLER WITH SLW

CONDUIT | 15V A.C.

CONDUIT 24V A.C.-

POWER SUPPLY

INSULATED COPPER

GROUND WIRE TO

GROUND GRID

NOT TO SCALE

WIRES

#8 SOLID

INSTALL MINIMUM 12"

ALL FITTINGS AND

NIPPLES THREADED


COCKS FACING OUTSIDE

FROM WALL OR

BUILDINGS INSTALL WITH TEST

 FX-IR-RB-DRIP-05
 SLEEVE AT ROAD


 1 1/2" = 1'-0"
 FX-IR-FX-AUXEQ-15

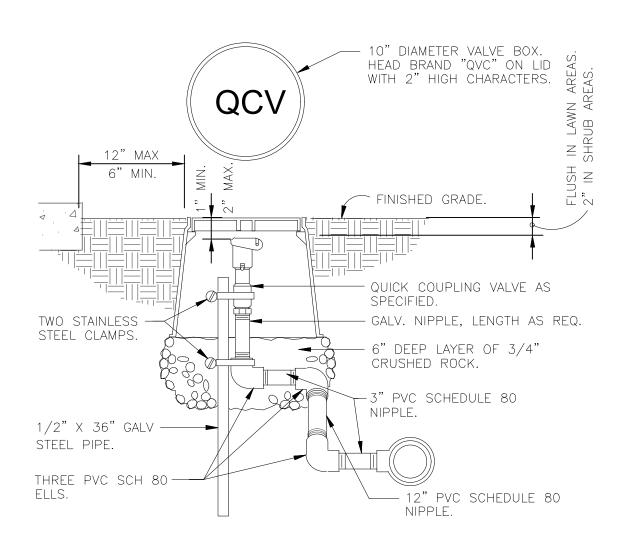


8 QUICK COUPLING VALVE IN BOX

1 1/2" = 1'-0"

FX-IR-FX-QUIC-03

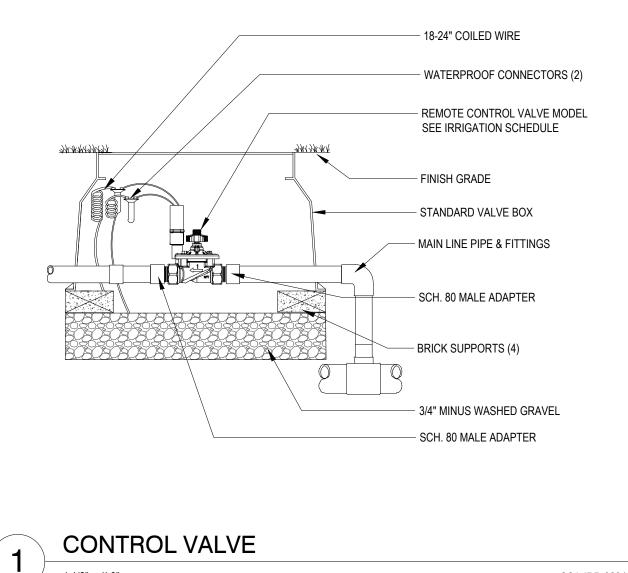

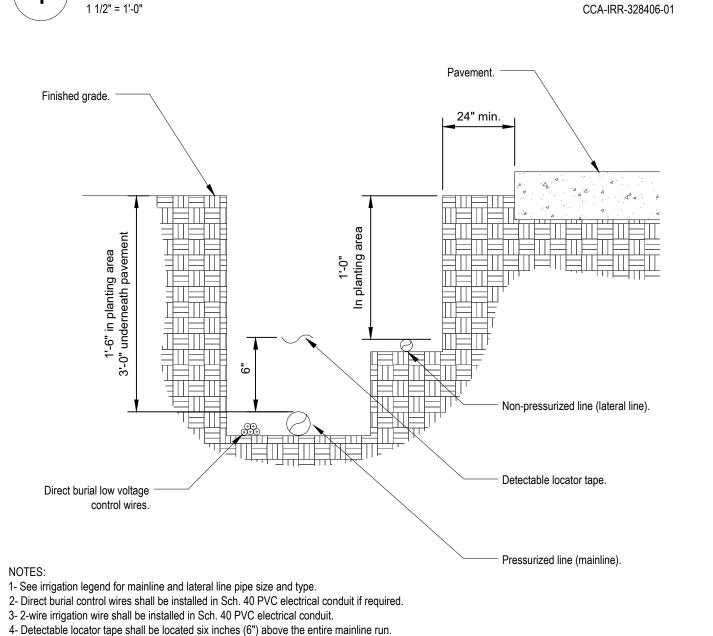

IRRIGATION TRENCHING


NETAFIM LINE FLUSHING VALVE BOX.


COMPRESSION RING (PROVIDED).

TECHLINE 17MM TUBING.

TWO BRICKS FOR BOX SUPPORT.

TWO GRAVEL SUMP (1 CUBIC FOOT).

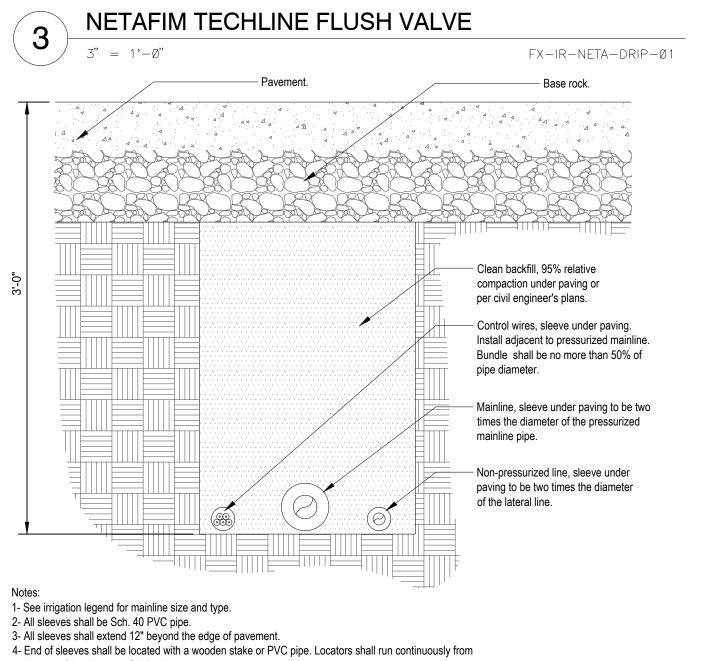

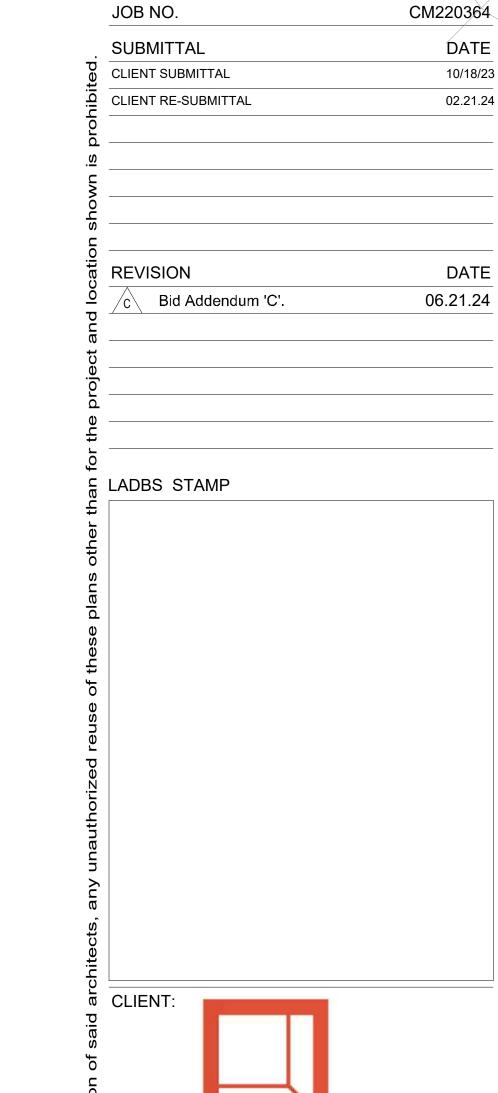



Rexford Industrial

FX-IR-FX-AUXEQ-08



LANDSCAPE DETAILS

L301

SHEET NO.

06/21/24

SHEET 7 OF 10

2- All sleeves shall be Sch. 40 PVC pipe.
3- All sleeves shall extend 12" beyond the edge of pavement.
4- End of sleeves shall be located with a wooden stake or PVC pipe. Locators shall run continuously from the end of the sleeve to finished grade.

PIPE BENEATH PAVEMENT

NTS

URBAN TREE FOUNDATION © 2014
OPEN SOURCE FREE TO USE

FX-IR-FX-AUXEQ-05

DECEMBER
RENEWALL

SIGNATURE

OR 2-1
SIGNATURE

DRIP-TYPE IRRIGATION SYSTEM

PART 1 GENERAL

1.1 RELATED DOCUMENTS

A. Drawings and general provisions of the Contract, including General and Supplementary Conditions and Division 1 Specification Sections, apply to this

1.2 SUMMARY

A. This Section includes sleeving and irrigation system.

B. Include a one-year of extended maintenance. Extended maintenance requirements are specified in Division 2 Section "Landscape and Irrigation"

1.3 QUALITY ASSURANCE AND REQUIREMENTS

A. Permits and Fees: Obtain and pay for any and all permits and all inspections as required.

B. Manufacturer's Directions: Manufacturer's directions and detailed drawings shall be followed in all cases where the manufacturers of articles used in this Contract furnish directions covering points not shown in the Drawings and Specifications.

C. Ordinances and Regulations: All local, municipal and state laws, rules, and regulations governing or relating to any portion of this work are hereby incorporated into and made a part of these Specifications, and their provisions shall be carried out by the Contractor. Anything contained in these Specifications shall not be construed to conflict with any of the above rules and regulations or requirements of the same. However, when these Specifications and Drawings call for or describe materials, workmanship or construction of a better quality, higher standard, or larger size than is required by the above rules and regulations, the provisions of these Specifications and Drawings shall take precedence.

D. Explanation of Drawings:

1. Due to the scale of Drawings, it is not possible to indicate all offsets, fittings, sleeves, etc., which may be required. Carefully investigate the structural and finished conditions affecting all of his work and plan his work accordingly, furnishing such fittings, etc., as may be required to meet such conditions. Drawings are generally diagrammatic and indicative of the work to be installed. The work shall be installed in such a manner as to avoid conflicts between irrigation systems, planting, utilities and architectural features.

2. All work called for on the Drawings by notes or details shall be furnished and installed whether or not specifically mentioned in the Specifications. 3. Do not willfully install the irrigation system as shown on the Drawings when it is obvious in the field that unknown obstructions, grade differences or discrepancies in area dimensions exist that might not have been considered in engineering. Such obstructions or differences should be brought to the attention of the Landscape Architect. In the event this notification is not performed, the Contractor shall assume full responsibility for any revision necessary.

1.4 ACTION SUBMITTALS

A. Material List:

1. Furnish the articles, equipment, materials, or processes *not* specified by name in the Drawings and Specifications. No substitutions will be allowed without prior written acceptance by the Landscape Architect.

2. Complete material list shall be submitted prior to performing any work. Material list shall include the manufacturer, model number and description of all materials and equipment to be used.

3. Equipment or materials installed or furnished without prior acceptance of the Landscape Architect shall be rejected and removed from the site at

your expense. 4. Review of any item, alternate or substitute indicates only that the product or products apparently meet the requirements of the Drawings and

Specifications on the basis of the information or samples submitted. 5. Manufacturer's warranties shall not relieve the Contractor of liability under the guarantee. Such warranties shall only supplement the guarantee.

B. Record and As-Built Drawings:

1. Provide and keep up to date a complete "as-built" record set of prints which shall be corrected daily and show every change from the original Drawings and Specifications and the exact "as-built" locations, sizes and kinds of equipment. Prints for this purpose may be obtained from the Architect at cost. This set of drawings shall be kept on the site and shall be used only as a record set.

2. These drawings shall also serve as work progress sheets, and the Contractor shall make neat and legible annotations thereon daily as the work proceeds, showing the work as actually installed. These drawings shall be available at all times for review on-site. 3. Before the date of the final review, transfer all information from the as-built prints to a reproducible drawing, procured from the Landscape Architect

at cost. All work shall be neat, in ink, and subject to the approval of the Landscape Architect. 4. Dimension from two (2) permanent points of reference, building corners, sidewalk or road intersections, etc., the location of the following items:

a. Connection to existing water lines. b. Connection to existing electrical power.

c. Gate valves. d. Routing of sprinkler pressure lines (dimension maximum 100 feet (30 m) along routing).

e. Sprinkler control valves. f. Routing of control wiring.

g. Quick coupling valves and drain valves.

h. Other related equipment as directed by the Landscape Architect.

5. Deliver the corrected and completed as-built reproducible prints to the Landscape Architect thirty (30) days before the date of final review. Delivery

of the reproducible prints will not relieve the Contractor of the responsibility of furnishing required information that may be omitted from the prints.

C. Controller Charts:

1. As-built reproducible prints shall be reviewed by the Landscape Architect before controller charts are prepared. 2. Provide one controller chart for each controller supplied.

3. The chart shall show the area controlled by the automatic controller and shall be the maximum size which the controller door will allow.

4. The chart is to be a reduced drawing of the approved as-built reproducible prints. In the event the controller sequence is not legible when the drawing is reduced, it shall be enlarged to a size that will be readable.

5. The chart shall be a reproducible drawing and a different color shall be used to indicate the area of coverage for each station. 6. When completed and approved, the chart shall be hermetically sealed between two pieces of plastic, minimum 6 mil.

7. These charts shall be completed and approved by the Landscape Architect prior to final review of the irrigation system.

8. Controller charts shall be attached to the inside surface of the corresponding controller enclosure prior to final review.

D. Operation and Maintenance Manuals:

1. Prepare and deliver to the Landscape Architect within ten (10) calendar days prior to completion of construction, a cover binder with three rings containing the following information:

a. Index sheet stating Contractor's address and telephone number, list of equipment with name and addresses of local manufacturer's

b. Catalog and parts sheets on every material and equipment installed under this Contract.

c. Guarantee statement.

d. Complete operating and maintenance instructions on all major equipment. e. Construction details from project.

f. Complete trouble shooting guide to common irrigation problems.

g. Winterization and spring start up procedures.

h. Chart of approximate watering times for spring, summer, fall and winter.

2. In addition to the above-mentioned maintenance manuals, provide the Owner's maintenance personnel with instructions for major equipment and show evidence in writing to the Landscape Architect at the conclusion of the project that this service has been rendered.

E. Maintenance Materials to be Furnished:

1. Supply as a part of this Contract, the following tools:

a. Two sets of tools required for removing, disassembling and adjusting each type of sprinkler and valve supplied on this project.

b. Two 5-foot (1500-mm) valve keys for operation of gate valves. c. Two keys for each automatic controller.

d. Three quick coupler keys and matching hose swivels for each type of quick coupling valve installed. e. Drip line Equipment, including the following --

1) One plastic handled punch 2) 10 feet (3 m) of dripper tubing for each dripper interval and discharge rate,

3) Six barbed couplings 4) Six barbed 90 elbows fittings

5) Six barbed tee fittings

6) Six 180 2-way adapter tees 7) Six male adapters with 3/4 inch (19 mm) FPT

8) One spare filter element of the mesh size indicated on the irrigation legend. 9) One line flushing valve

10) Two regulator springs of the colored and regulating pressure indicated on the irrigation legend. 11) Six dripper plug rings.

12) The above-mentioned equipment shall be turned over to the Owner at the conclusion of the project. Before final review can occur, evidence that the Owner has received material must be shown to the Landscape

1.5 PRODUCT DELIVERY, STORAGE AND HANDLING

A. Handling of PVC pipe and fittings: The Contractor is cautioned to exercise care in handling, loading, unloading, and storing PVC pipe and fittings. All PVC pipe shall be transported in a vehicle which allows the length of pipe to lie flat so as not to subject it to undue bending or concentrated external load at any point. Any section of pipe that has been dented or damaged will be discarded, and, if installed, shall be replaced with new piping. B. Provide all equipment called for by the Drawings.

1.6 FIELD QUALITY CONTROL AND SITE VISITS

A. Required Site Visits During Construction:

1. Pre-Installation Conference: Contractor, Installer, Landscape Architect, Owner's Representative, and other pertinent parties to attend Pre-Installation Conference for landscape and irrigation prior to starting work on site.

2. Landscape Architect will make three (3) site visits during construction to review the irrigation system at the following stages:

a. Prior to pipe cover-up for mainline pressure test and lateral review

b. After sprinkler head installation c. Punch list coverage test.

3. Punch List Review: Landscape Architect will make one site visit to review the completed work. Landscape Architect to obtain Contractor's Punch List prior to visit and to schedule the visit when the work is complete enough to negate the need for additional visits.

B. Required Site Visit After Construction:

1. Landscape Architect will make a one (1) year Guarantee Site Visit.

C. Submit reports of site visits to Architect and Owner.

D. Site Visit Schedule: Contractor shall be responsible for notifying the Landscape Architect and Owner's Representative in advance for the following reviews, according to the time indicated:

1. Pre-Installation Conference: Five (5) business days.

4. Punch List Review And Coverage Test: Three (3) business days.

2. Mainline Pressure Test and Lateral Review: Three (3) business days. 3. Sprinkler Head Installation: Three (3) business days.

5. One-Year Guarantee Site Visit: Ten (10) business days

1.7 GUARANTEE

A. The guarantee for the irrigation system shall be made in accordance with the attached form. The General Conditions and Supplementary Conditions of these Specifications shall be filed with the Owner or his representative prior to acceptance of the irrigation system.

B. A copy of the guarantee form shall be included in the operations and maintenance manual.

C. The guarantee form shall be retyped onto the Contractor's letterhead and contain the following information:

GUARANTEE FOR IRRIGATION SYSTEM

We hereby guarantee that the irrigation system we have furnished and installed is free from defects in materials and workmanship, and the work has been completed in accordance with the Drawings and Specifications, ordinary wear and tear and unusual abuse, or neglect excepted. We agree to repair or replace any defects in material or workmanship which may develop during the period of one (1) year from date of acceptance and also to repair or replace any damage resulting from the repairing or replacing of such defects at no additional cost to the Owner. We shall make such repairs or replacements within a reasonable time, as determined by the Owner, after receipt of written notice. In the event of our failure to make such repairs or replacements within a reasonable time after receipt of written notice from the Owner, we authorize the Owner to proceed to have said repairs or replacements made at our expense and we will pay the costs and charges therefore upon demand.

PROJECT: SIGNED: ADDRESS: DATE OF ACCEPTANCE: _____

PART 2 PRODUCTS

2.1 MATERIALS

A. General: Use only new materials of brands and types noted on Drawings and specified herein.

B. PVC Pressure Main Line Pipe and Fittings

1. Pressure main line piping shall be PVC Schedule 40.

2. Pipe shall be made from an NSF approved Type I, Grade I, PVC compound conforming to ASTM resin specification D1784. All pipe must meet requirements as set forth in Federal Specification PS-22-70, with an appropriate standard dimension ratio (S.D.R.). (Solvent-weld pipe). 3. Pipe shall be made from NSF approved Type I, Grade I PVC compound conforming to ASTM resin specification 1785. All pipe must meet

requirements as set forth in Federal Specification PS-21.70. (Solvent-weld pipe).

4. PVC solvent-weld fittings shall be Schedule 40, 1-2, II-I NSF approved conforming to ASTM test procedure D2466. 5. Solvent cement and primer for PVC solvent-weld pipe and fittings shall be of type and installation methods prescribed by the manufacturer.

a. Manufacturer's name b. Nominal pipe size

6. All PVC pipe must bear the following markings:

c. Schedule or class

d. Pressure rating in P.S.I. e. NSF (National Sanitation Foundation) approval

7. All fittings shall bear the manufacturer's name or trademark, material designation, size, applicable I.P.S. schedule and NSF seal of approval.

C. PVC Non-Pressure Lateral Line Piping and Sleeving:

1. Non-pressure buried lateral line piping shall be PVC Schedule 40 with solvent-weld joints. 2. Pipe shall be made from NSF approved, Type I, Grade II, PVC compound conforming to ASTM resin specification D1784. All pipe must meet requirements set forth in Federal Specification PS-22-70 with an appropriate standard dimension ratio (S.D.R.).

D. Connections between main lines and control valves shall be of Schedule 80 PVC (threaded both ends) nipples and fittings.

E. All PVC pipe used on the site shall be from the same manufacturer.

F. Dripper Tubing with Pressure Compensating Emitters: Tubing shall be of nominal sized 1/2-inch (12 mm) low density, ultra-violet-resistant, linear polyethylene tubing with internal pressure-compensating, self-cleaning, integral drippers at a specified interval.

G. Insert Barbed Fittings: All insert barbed fittings shall be constructed of molded, ultra-violet-resistant, plastic. Each fitting shall have a minimum of two ridges or bars per outlet. All fittings shall be of one manufacturer and shall be available in one of the following end configurations:

1. barbed insert fittings 2. male pipe threads (MPT) with barbed insert fittings or 3. female pipe threads (FPT) with barbed insert fittings.

2.2 QUICK COUPLER VALVES

A. Quick coupler valves shall be as listed on the Drawings. 2.3 CONTROLLERS

A. Controllers shall be as listed on the Drawings.

B. Provide and install automatic irrigation controller in approximate location shown on Drawings. 120 V.A.C. power and conduit to outside planting area as shown on electrical drawings.

C. Final electrical hook-up shall be the responsibility of the irrigation contractor.

2.4 LINE FLUSHING VALVE

A. The line flushing valve shall be constructed of black molded plastic and shall be a normally closed hydraulic valve, which flushes based on volumetric

quantities of water. Inlet and outlet configurations shall be of one of the following configurations: B. 1/2-inch (12 mm) MPT, or

C. Insert barbed fitting: The top of the line flushing valve shall be domed-shaped to allow water-transported debris to drain away from one of the eight orifices in the top of the valve. The valve shall be non-serviceable and capable of automatically operating during initial system pressure build-up to discharge one gallon of water per 15 gpm demand at 25 psi maximum or 4 psi minimum.

2.5 REMOTE CONTROL VALVES

A. Remote control valves shall be as noted on irrigation schedule. Sizes of remote control valves shall be as listed on the Drawings.

2.6 CONTROL WIRE

A. Control wire shall be individual copper wires with UL approval for direct burial in ground, minimum size #14-1(not multi-strand). Common ground wire shall have white insulating jacket; control wire shall have insulating jacket of color other than white; spare wires shall be yellow. Splices shall be made with 3M #3576 Scotchlok seal packs or approved.

2.7 DISC FILTER

A. The disc filter body shall be molded of black plastic with male pipe threads (MPT) for both the inlet and outlet ports. A threaded cap on one end of the body shall be capable of periodic servicing by unscrewing the cap from the main filter body. On the 3/4-inch (19 mm) model, a manual shut-off valve shall be co-molded to the opposing end of the removable cap as part of the main body. This device shall be capable of closing off the inlet port so the disc element can be removed when the main line is still pressurized.

B. The filter elements shall be either disc-type or a canister screen filter. The disc-type shall be color-coded in one of four colors denoting filtration of 80, 120, 140, and 200 mesh. The canister-type screen shall be available in three levels of filtration, 80, 120, and 140 mesh.

2.8 BOXES FOR AUTOMATIC CONTROL VALVES

A. Boxes for remote control valves shall be Carson Model 1419 plastic valve box. Provide extensions as required to flush box with finish grade.

2.9 AIR/VACUUM RELIEF VALVES

A. Air/vacuum relief valves shall be constructed of grey plastic with an internal sliding poppet valve that is capable of venting air or vacuum to the atmosphere only. The main body shall have a 1/2-inch (12 mm) male pipe thread (MPT).

B. Operating pressure range for the air/vacuum relief valve shall be 7 psi minimum to 140 psi maximum.

2.10 BACKFLOW PREVENTION UNITS

A. Backflow prevention units shall be of the size and type shown. Install backflow prevention units in accord with irrigation construction details, with positive drainage and room for servicing.

B. Wye strainers at backflow prevention units shall have a 125-lb (57 kg) flanged cast iron body with 100 mesh screen.

2.11 BALL VALVES

A. Ball valves 2 inches and smaller shall 400 psi/27.6 Bar Non-Shock Cold Working Pressure brass ball valve with Threaded - Standard Port -

Blowout-Proof Stem - TFE Seats, Nibco or approved.

2.12 DRAIN ROCK

A. Un-fractured rock, 100 percent passing a 1-1/2-inch (38 mm) square sieve and 0 percent passing a 3/4-inch (19 mm) sieve.

A. 2-inch (50 mm) diameter class 200 PVC, length as required. Caps, Rain Bird #63100. Enclose all drain valves in protective sleeves with locking caps.

2.16 MISCELLANEOUS INSTALLATION MATERIALS

2.13 PROTECTIVE SLEEVES WITH LOCKING CAPS

2.14 SLEEVES FOR PIPING UNDER PAVING A. PVC class 200, sizes as noted, depth as required for piping.

tool to secure the tubing around the insert barbed fitting.

B. Extend piping 12 inches (300 mm) into planter, plug ends and mark at grade with flag label.

2.15 STAINLESS STEEL CLAMPS

B. Interior clamp wall shall be smooth to prevent crimping or pinching of tubing.

A. Tubing clamps shall be constructed to 304 AISI stainless steel and shall be one "ear" type. This "ear" shall be capable of being pinched with a pinching

A. Solvent cement and primers for solvent weld joints shall be of make and type approved by manufacturer(s) of pipe and fittings. Cement shall be

2.17 MISCELLANEOUS EQUIPMENT A. Provide all equipment called for by the Drawings.

maintained at proper consistency throughout use.

PART 3 EXECUTION 3.1 REVIEW

3.2 PREPARATION

A. Site Conditions:

1. All scaled dimensions are approximate. The Contractor shall check and verify all size dimensions and receive Landscape Architect's approval prior

to proceeding with work under this section. 2. Exercise extreme care in excavating and working near existing utilities. Contractor shall be responsible for damages to utilities which are caused by his operations or neglect. Check existing utilities drawings for existing utility locations. 3. Coordinate installation of sprinkler irrigation materials, including pipe, so there shall be no interference with utilities or other construction or

difficulty in planting trees, shrubs, and ground cover. 4. The Contractor shall carefully check all grades to satisfy himself that he may safely proceed before starting work on the landscape sprinkler system. 5. Coordinate installation of sleeves with other trades.

A. Physical Layout:

1. Prior to installation, stake out all pressure supply lines, routing and location of sprinkler heads. Begin dripper tubing layout 4 to 6 inches (100 to 150 mm) away from both hard surfaces; (i.e., concrete sidewalks, curbs, asphalt, and/or undefined edges; i.e. shovel-cut headers). Mark tubing intervals on the ground with flags, paint, or some other markings that can be maintained throughout the installation.

1. Connect to the water supply at the approximate point of connection as indicated on the Drawings. 2. Contractor is responsible for minor changes caused by actual site conditions.

B. Water Supply:

C. Electrical Supply: 1. Electrical connections for automatic controller shall be made to electrical points of connections as indicated on the Drawings.

3.3 EXCAVATING AND TRENCHING

A. Excavation shall be in all cases ample in size to permit the pipes to be laid at the elevations intended and to permit ample space for joining.

B. Make trenches for pipelines deep enough to provide minimum cover from finish grade as follows:

2. Contractor is responsible for minor changes caused by actual site conditions.

2. Make minor changes to conform to ground conditions and note on as-built drawings.

1. 24 inches minimum cover over main lines to control valves and quick coupling valves. 2. 24 inches minimum cover over control wires from controller to valves.

shrubs, 15 gallon size and larger, then place tubing at the row spacing interval indicated on the plans.

tubing layout. In irregular areas, water outlets too close to fixed improvements shall be capped off with an dripper plug ring.

directly adjacent or over one another. Reinstall all rejected piping in accordance with this requirement. C. Restore surfaces, existing underground installations, etc., damaged or cut as a result of excavations, to original conditions in manner approved by the

4. All lines shall have a minimum clearance of 6 inches (150 mm) from each other and from lines of other trades. Parallel lines shall not be installed

Landscape Architect or Owner's Representative. D. Where other utilities interfere with irrigation trenching and pipe work, adjust the trench depth as instructed by the Landscape Architect or Owner's

Representative.

3.4 DRIPPER TUBING INSTALLATION

3. 18 inches minimum cover over lateral lines to sprinkler heads.

A. Dripper tubing can be installed in one of the following methods: 1. Over-excavation: In small areas, over-excavate the entire area to a depth of 4 inches (100 mm) below finish grade. Plant all specimen trees and

2. Pipe Pulling: In larger areas where ground disruption is to be minimized, pneumatic tire, pipe pulling machinery shall be used. Pothole at the ends of each run for making connection to supply and exhaust headers of rigid PVC pipe. Maintain 4-inch (100 mm) cover. B. Dripper tubing can be installed with the water outlets facing upward or downward. Offset the water outlets to form a triangular pattern throughout the

C. Barbed Fittings: Connect dripper tubing to barbed fittings by pushing on and over both barbs until the tubing has seated against another piece of tubing or has butted against another portion of the barbed fitting.

over insert barbed fitting. Place clamp between the first and second ridge of the barbed fittings and crimp the "ear" of the clamp tightly. Crimp the

D. Pipe Clamping: When operating pressure exceeds 45 psi, stainless steel pipe clamps shall be used. Slip clamps over tubing before slipping tubing

"ear" twice to ensure proper seating.

3.5 BACKFILLING

A. Backfill only after piping has been tested, reviewed and accepted. B. Backfill material shall be the earth excavated from the trenches, free from rocks, concrete chunks, and other foreign or course materials. Carefully select backfill that is to be placed next to plastic pipe to avoid any sharp objects which may damage the pipe. Place shovel fulls of dirt on dripperline tubing

to keep them in place and maintain row spacing. If soil is rock-laden, isolate from pipe with minimum 2 inches (50 mm) of clean, coarse sand.

D. Place backfill materials in 6 inches (150 mm) layers and compact by jetting or tamping to a minimum compaction of 90 percent of original soil density.

C. All pipe under asphalt paving shall be backfilled with 4 inches (100 mm) of clean sand on all sides of pipe.

E. Dress off areas to finish grades and remove excess soil, rocks or debris remaining after backfill is completed. F. If settlement occurs along trenches, and adjustments in pipes, valves and sprinkler heads, soil sod, or paving to the proper level or the permanent

grade, subcontractor, as part of the work under this Contract, shall make all adjustments without extra cost to the Owner.

A. Use piping as indicated on drawings. Install in accordance with industry standards and manufacturer's recommendations.

B. Install all PVC piping using two-step solvent weld process only. Cure joints at least 24 hours.

C. Paint all galvanized pipe below grade with at least one heavy coat of approved paint to prevent corrosion. D. Cap or plug openings as pipeline is assembled to prevent entrance of dirt or obstruction. Remove caps or plugs only when necessary to continue

E. Where pipes or control wires pass through sleeves, provide removable non-decaying plug at ends of sleeve to prevent entrance of earth.

B. Locate valves no closer than 12 inches (300 mm) from walk edges, building and walls. Install valve box parallel to walk, curb or edge.

3.7 REMOTE CONTROL VALVES A. Install where shown and group together in straight lines where practical. Limit one remote control valve per box.

D. Install in planting areas where possible.

C. Thoroughly flush main line before installing valve.

3.8 DISC FILTER

A. Install the disc filter, horizontally level, below grade and as indicated in the installation details. the position of the disc filter in the valve box shall be off-center to allow for removal of the disc element for periodic servicing.

3.9 AIR/VACUUM RELIEF

A. Install the air/vacuum relief valve below grade and at the highest elevation within each zone. Depending on the site conditions and tubing layout, multiple air/vacuum relief valves will be required. Place the valve within a round valve box with a locking cover and a 1 cu. ft., 3/4-inch (19 mm) gravel sump as noted on the details.

B. Interconnect tubing with an air/vacuum relief lateral perpendicular to other tubing laterals for systems that are located on mounds or berms with more than a 3-foot (900 mm) elevation differential.

3.10 LINE FLUSHING VALVE

A. Install the line flushing valve horizontally level and below grade at each exhaust header. Locate in a valve box with the dome-shape of the valve facing upward. Include a minimum of 1 cu. ft. of 3/4-inch (19 mm) gravel in the bottom of the valve box.

D. Splicing will be permitted only on runs exceeding 500 feet (150 m). Locate all splices at valve locations within valve boxes. All splicing shall be made

3.11 AUTOMATIC CONTROL WIRING

A. Run lines along mains wherever practical. Tie wires in bundles with pipe wrapping tape at 10-foot (3-meter) intervals and allow slack for contraction between strappings.

B. Loop a minimum of 3 feet (900 mm) of extra wire in each valve box; for control wire, spares and ground wire.

C. Connections shall be made by crimping bare wires with brass connectors and sealing with epoxy resin sealer packs.

with Scotch-Lok #3576 connector sealing packs or approved. Field splices between the automatic controller and electrical control valves will not be allowed without prior approval of the Landscape Architect or Owner's Representative.

E. Where control wires lines pass under paving, they shall pass through PVC class 200 sleeves. F. Provide two complete spare wire runs from controller through every valve box for future use. Test for continuity at punch list. Provide an extra 3 feet

sprinkler heads, open control valves and use a full head of water to flush out the system.

(900 mm) (in each valve box and permanently label "Spare".

3.12 AUTOMATIC CONTROLLER

A. Connect control lines to controller in sequential arrangement according to assigned identification number of valve. Control lines shall be labeled at controller with permanent non-fading labels indicated identification number of valve controlled.

3.13 FLUSHING OF SYSTEM A. After all new sprinkler pipe lines and risers are in place and connected, all necessary diversion work has been completed, and prior to installation of

B. Install sprinkler heads only after flushing of system has been accomplished and approved by the Landscape Architect or Owner's Representative.

A. Thoroughly flush lines before installing heads or QCV's.

the Drawings.

3.16 FIELD QUALITY CONTROL

3.14 SPRINKLER HEADS AND QUICK COUPLER VALVES

B. Locate heads and QCV's as shown in the Drawings and details.

3.15 EXISTING TREES

A. Where it is necessary to excavate adjacent to existing trees, the Contractor shall use all possible care to avoid injury to trees and tree roots. B. Excavation in areas where 2 inches (50 mm) and larger roots occur shall be done by hand.

C. All roots 2 inches (50 mm) and larger in diameter directly in the path of pipe or conduit, shall be tunneled under and shall be heavily wrapped with burlap, to prevent scarring or excessive drying.

D. Where a ditching machine is run close to trees having roots smaller than 2 inches (50 mm) in diameter, the wall of the trench adjacent to the tree shall

C. Adjust sprinkler heads for proper distribution and trim. In no case shall spacing exceed maximum recommended by the manufacturer and as listed on

E. Trenches adjacent to trees shall be closed within 24 hours; and, where this is not possible, the side of the adjacent to the trees shall be kept shaded

A. Adjustment of the System: 1. The Contractor shall flush and adjust all drip lines for optimum performance and to prevent overspray onto walks, roadways, and buildings as

3. All sprinkler heads shall be set perpendicular to finish grades unless otherwise designated on the drawings. B. Testing of Irrigation System:

sustained to the work of others to original conditions.

and accepted in writing.

be hand trimmed, making clean cuts through.

1. The Contractor shall request the presence of the Landscape Architect in writing at least 3 business days in advance of testing. 2. Test all pressure lines under hydrostatic pressure of 150 pounds per square inch, and prove watertight for 1/2 hour with maximum 5 psi loss. 3. Sustain pressure in lines for not less than two hours. If leaks develop, replace joints and repeat test until entire system is proven watertight.

4. All hydrostatic tests shall be made only in the presence of the Landscape Architect. No pipe shall be backfilled until it has been reviewed, tested

due to deviations from plans, or where the system has been willfully installed as indicated on the Drawings when it is obviously inadequate,

2. If it is determined that adjustments in the irrigation equipment will provide proper and more adequate coverage, the Contractor shall make such

5. Furnish necessary force pump and all other test equipment. 6. When the landscape irrigation system is completed, perform a coverage test in the presence of the Landscape Architect to determine if the water coverage for planting areas is complete and adequate. Furnish all materials and perform all work required to correct any inadequacies of coverage

B. The Landscape Architect or Owner's Representative reserves the right to waive or shorten the operation period.

the reviewer shall be reworked to the complete satisfaction of the Landscape Architect or Owner's Representative.

project for all new and existing modified work per Division 2 Section "Landscape and Irrigation Maintenance".

adjustments prior to planting. Adjustments may also include changes in nozzle sizes and degrees of arc.

without bringing this to the attention of the Landscape Architect or Owner's Representative. This test shall be accomplished before any ground 7. Upon completion of each phase of work, entire system shall be tested and adjusted to meet site requirements.

3.17 MAINTENANCE

A. The entire irrigation system shall be under full automatic operation for a period of 7 days prior to any planting.

3.18 CLEAN-UP A. Clean-up as each portion of work progresses. Remove refuse and excess dirt from the site. Sweep or wash all walks and paving. Repair any damage

charge has been paid.

3.20 EXTENDED MAINTENANCE

3.19 PUNCH LIST REVIEW PRIOR TO ACCEPTANCE

A. The Contractor shall operate each system in its entirety for the Landscape Architect at time of punch list review. Any items deemed not acceptable by

previously noted corrections, or without preparing the system for review, he shall be responsible for reimbursing the Architect at the rate of 2-1/2 times

the normal office hourly rate per hour portal to portal (plus transportation costs) for the inconvenience. No further reviews will be scheduled until this

A. In addition to the maintenance required until final acceptance, provide irrigation maintenance for a period of one year after final acceptance of the entire

B. The Contractor shall show evidence to the Landscape Architect or Owner's Representative that the Owner has received all accessories, charts, record drawings, and equipment as required before final review can occur. C. No review will commence without as-built drawings. In the event the Contractor calls for an review without as-built drawings, without completing

B. The installer shall also provide the "Owner" with a fee to perform the maintenance required for a period of one year the 90 day Extended Maintenance Period per Division 2 Section "Landscape and Irrigation Maintenance".

END OF SECTION

CM220364 JOB NO. **SUBMITTAL** DATE CLIENT SUBMITTAL 10/18/23 CLIENT RE-SUBMITTAL 02.21.24

DATE REVISION 06.21.24 Bid Addendum 'C'.

LADBS STAMP

ซี CLIENT:

Rextord Ш

<

M

2 S



BSBDESIGN.COM

· LANDSCAPE SPECIFICATIONS

L400

SHEET NO.

06/21/24

SHEET 8 OF 10

LANDSCAPE PLANTING

PART 1 GENERAL

1.1 RELATED DOCUMENTS

A. Drawings and general provisions of the Contract, including General and Supplementary Conditions and Division 1 Specification Sections, apply to this Section.

1.2 SUMMARY

A. This Section includes all materials, equipment and labor necessary for finish grading, planting of trees, shrubs and ground cover and lawn, and rough grass seeding; protection, guarantee and replacement, one year extended maintenance and related items necessary to complete the work indicated on the Drawings and/or specified. Maintenance requirements are specified in Section Landscape and Irrigation Maintenance.

1.3 QUALITY ASSURANCE

A. Installer/Supplier Qualifications:

1. To be "Specialist," with minimum five (5) years experience in the field.

Under this section, either the Supplier, or an individual or firm under the Supplier's direct supervision, is to perform the work. In either case, he/she is to be registered in the State of California.

B. Plant material in accordance with the following reference specifications where applicable:

1. "Ornamental Evergreen and Deciduous Plants, Nursery Stock Standards for the Department of Agriculture" (Order No. 1229, 1230, 1320, 1321, 1322).

"American Standard for Nursery Stock," (ASNS), current edition. Hortus III, current edition.

4. Plant names shall conform to the latest edition of "Standardized Plant Names" as adopted by American Joint Committee of Horticulture Nomenclature.

C. Fertilizer: Conform to California State Department of Agriculture Laws and Federal Specification 0-F-241D pertaining to commercial

D. Seed: Conform to USDA rules for seed certification.

Header Board: Aluminum, $\frac{3}{16}$ x 4", mill finish.

1.4 ACTION SUBMITTALS

A. Within 30 days after award of contract, submit documentation that all plant material, seed, and sod has been ordered.

B. Submit for review the following items:

One quart topsoil sample for each type specified.

One quart mulch sample. 3. One quart compost sample.

C. Submit 3 copies of planting schedule showing scheduled dates for each type of planting in each area of site within 30 days after award of contract.

D. Submit source and proposed fertilizers including manufacturer's cut sheets.

1.5 SUBSTITUTIONS

A. Approval of substitutions will be made only in exceptional cases when the Contractor submits satisfactory evidence that, through no fault of his own, specified or otherwise approved items cannot be obtained in time to avoid delay of the work. In any case, substitutions are subject to acceptance by the Landscape Architect and Owner's Representative.

B. Trees and shrubs of larger size may be used if acceptable to Landscape Architect and Owner's Representative, and if sizes of roots or balls are increased proportionately.

1.6 PRODUCT DELIVERY, STORAGE AND HANDLING

A. Deliver packaged materials in containers showing weight, analysis and name of manufacturer. Protect materials from deterioration during delivery and while stored at the site.

B. Trees and Shrubs

Provide freshly dug trees and shrubs. Do not use trees or shrubs which have been in cold storage or heeled-in. Do not prune prior to delivery. Do not bend or bind-tie trees or shrubs in such a manner as to damage bark, break branches or

destroy natural shape. Provide protective covering during delivery. 3. Deliver trees and shrubs after preparations for planting have been completed and plant immediately. If planting is delayed more than 6 hours after delivery, set trees and shrubs in shade, protect from weather and mechanical damage, and keep roots moist.

C. Do not remove container-grown stock from containers until planting time.

D. Seed: Store seed as recommended by supplier.

E. Sod: Protect pallets of sod from sun, and water thoroughly.

1.7 JOB CONDITIONS

A. Installer must examine the sub-grade, verify the elevations, and observe the conditions under which work is to be performed. Do not proceed with the work until unsatisfactory conditions have been corrected in a manner acceptable to the installer.

B. Proceed with and complete the landscape work as rapidly as portions of the site become available, working within the seasonal limitations for each kind of landscape work required.

C. Determine location of underground utilities and perform work in a manner which will avoid possible damage. Hand excavate, as required, to minimize possibility of damage to underground utilities. Maintain grade stakes set by others until removal is mutually agreed

upon by all parties concerned. D. When conditions detrimental to plant growth are encountered, such as rubble fill, adverse drainage conditions, or obstructions, notify Landscape Architect and Owner's Representative before planting. Take any steps required to improve drainage, including mounding around

trees/shrubs, day-lighting pits, and adjustments to locations with owner approval. D. Plant or install materials during normal planting seasons for each type of landscape work required. Correlate planting with specified maintenance period to provide maintenance for one year after acceptance by the owner.

E. Provide all necessary safeguards, as approved and/or required by the Landscape Architect and Owner's Representative, for the protection of all planted areas until final review/acceptance is accomplished, or for such time as it requires to assure vigorous establishment

1.8 GUARANTEE

of the plant material.

for a full growing season.

A. Guarantee trees, shrubs and ground cover for a period of one year after date of acceptance against defects including death and unsatisfactory growth, except for defects resulting from neglect by Owner, abuse or damage by others, or unusual phenomena or incidents which are beyond Landscape Contractor's control. Replace all dead plants and plants with numerous dead limbs in the same size as those originally planted.

B. Seeded/Sodded Lawn Areas: Guarantee a relatively uniform, acceptable stand of grass with no bare spots over 3-inch (75 mm) square in seeded or sodded areas at time of punch list review. Re-install, in the manner originally specified, any area which fails to vigorously establish a uniform stand for any reason whatsoever. Fill to finish grade with approved topsoil and reseed or re-sod all areas which evidence settlement. Repeat as required until final acceptance at Contractor's expense.

C. Remove and replace trees, shrubs and ground cover found to be dead or in unhealthy condition during guarantee period. Plant missing trees, shrubs and plants. Make replacements during growth season following end of guarantee period. Furnish and plant replacements which comply with requirements shown and specified. Also, replace trees and shrubs, which are in doubtful condition at end of guarantee period, unless, in the opinion of the Landscape Architect and Owner's Representative, it is advisable to extend guarantee period

D. The Landscape Architect and Owner's Representative will review at the end of the extended guarantee period, if any, to determine

acceptance or rejection.

Rough seeded areas: Guarantee a relatively uniform, acceptable stand of grass with no bare spots over 12-inch (300 mm) square at time of punch list review. Reseed any areas, which fail to vigorously establish a uniform stand for any reason whatsoever. Repeat as required until final acceptance at Contractor's expense.

1.9 FIELD QUALITY CONTROL AND SITE REVIEWS

A. Required Site Visits During Construction:

Pre-Installation Conference: Contractor, Installer, Landscape Architect, Owner's Representative, and other pertinent parties to attend Pre-Installation Conference for landscape and irrigation prior to starting work on site. 2. Landscape Architect will make 3 site visits during construction to review the following landscape items:

Subgrades prior to placement of topsoil. Finish grades prior to any planting or seeding

Plant material prior to installation. Staked plant locations prior to installation.

Punch List Review: Landscape Architect will make one site visit to review the completed work. Landscape Architect to obtain Contractor's Punch List prior to visit and to schedule the visit when the work is complete enough to negate the need for additional visits.

Required Site Visit After Construction:

Landscape Architect will make a one year Guarantee Site Visit.

C. Submit reports of site visits to Architect and Owner.

D. Site Visit Schedule: Contractor shall be responsible for notifying the Landscape Architect and Owner's Representative in advance for the following reviews, according to the time indicated:

Pre-Installation Conference: 5 business days. Other Site Visits During Construction: 3 business days.

Punch List Review: 3 business days. One Year Guarantee Site Visit: 10 business days.

1.10 PROTECTION

Protect materials against harm from wind and unusual weather. Special planting techniques, defoliating, wilt-proofing, or spray misting may be required by Landscape Architect for unseasonal planting, prolonged periods of drought, and the like.

Soak significantly dry root balls before planting.

Protect surrounding areas and surfaces to preclude damage, including erosion and trespassing, and injury to the public.

Perform no work in, over, or adjacent to planting areas without proper protection and safeguards.

C. Take particular care to prevent pavement staining from fertilizers.

PART 2 PRODUCTS

2.1 TOPSOIL

A. Planting Mix: specified imported topsoil amended with twenty-five (25%) percent (by volume) native soils from planting pit.

Imported Topsoil: Screened, sandy loam, weed-free, minimum six (6%) percent organic material, as approved by Landscape Architect or Owner's Representative. Test at approved testing lab for pH, trace minerals, N, P, K and amendment recommendations to achieve a pH balanced fertile mix with minimum six (6%) percent organic materials derived from compost. Incorporate starter fertilizer and plant tabs plus fertilizer and soil amendments as recommended in report at no additional cost. Submit invoice of amendments when requested.

2.2 PLANTS / SEED

A. Conform to American Association of Nurserymen's specifications true to name. Plants to be first quality, well foliated with well-developed root systems and a normal, well-shaped trunk, limbs, stems and a head. Plants deemed unsuitable may be rejected before or after delivery. Plant material is required to be free of evidence of disease, insects, insect eggs, and larvae. Oversize plants may be used with approval, but at no increase in price. Balls that are cracked, broken or dry to the center will be rejected.

Acclimatize any plant materials not grown in California for a minimum of one growing season prior to installation.

C. Deciduous Trees

Provide trees of height and caliper listed or shown and with branching configuration recommended by ANSI Z60.1 for type and species required. Provide single-stem trees except where special forms are shown or listed.

a. Containerized trees are acceptable for use on the project.

Deciduous Shrubs

Provide shrubs of the height shown or listed and with not less than the minimum number of canes required by ANSI Z60.1 for the type and height of shrub required.

Provide balled and burlapped deciduous shrubs.

Container-grown shrubs will be acceptable in lieu of balled and burlapped deciduous shrubs, subject to specified limitations for container-grown stock.

E. Coniferous and Broad-leafed Evergreens

1. Provide evergreens of the sizes shown or listed. Dimensions indicate minimum spread for spreading and semi-spreading type evergreens and height for other types, such as cone, pyramidal, broad upright, and columnar. 2. Provide normal quality evergreens with well-balanced form complying with requirements for other size relationships to the primary dimension shown.

Container-grown evergreens will be acceptable, subject to the specified limitations for container-grown stock.

F. Ground Cover: Provide plants established and well-rooted in removable containers and with not less than the minimum length of runners required by ANSI Z60.1 for the pot size shown or listed. Install ground cover at centers as indicated on Drawings in all planting beds in straight, even consistent rows.

G. Rough Grass: Refer to Drawings for seed mix and application rate.

H. Seeded Lawn: Refer to Drawings for seed mix and application rate.

I. Sod: Number 1 quality, locally grown seed blend, premium grade, free from weeds as approved.

Compost: 5/8 inch (916 mm) minus fully composted vegetative material from approved source, submit sample for approval.

2.3 FERTILIZERS AND SOIL AMENDMENTS

A. General: Approved brands conforming to applicable state fertilizer laws. Uniform in composition, dry, free flowing, delivered to the site in original unopened containers, each bearing the manufacturer's guaranteed analysis. Additional amendments or fertilizers may be required based upon the required soil test but at a minimum should include:

ORGANIC AMENDMENTS

a. Organic Amendment shall be derived from bark of white fir, red fir or pine; nitrogen stabilized; ground, and screen sized.

1. Particle size: minimum 95% passing 4-mesh screen

minimum 80% passing 8-mesh screen Nitrogen Content - 0.5% based on dry weight for redwood sawdust. 1.0% based on dry weight for fir or pine bark. Note: Pine sawdust NOT acceptable.

Salinity - maximum conductivity 4.5 millimohs/cm at 25 degrees C, as measured by saturation extract method. Organic content - minimum 90% based on dry weight.

Acceptable products meeting these specifications are 'Forest Humus' by Seguoia Forest Products; 'Forest Bark Humus' by Seguoia Horticultural Products; 'Bark Humus' by Long Beach Redwood Corporation, or other approved equal as approved by the Owner's Representative.

ORGANIC FERTILIZER

Organic Fertilizer shall be processed sewer sludge with minimum content of 1% Nitrogen and 2% Phosphoric Acid, which has been processed in such a manner as to retain the normal bacteria content. An approved nitrohumus may be substituted. NOTE: Manure shall not be used at any time.

3. COMMERCIAL FERTILIZER

Commercial fertilizer shall be 'Gro-Power' 5-3-1, as supplied by Southern California Organic Fertilizer Company, 16-6-8 commercial fertilizer, 12-12-12 commercial fertilizer, or as otherwise noted on plans. Commercial Fertilizer shall be in pelleted or granular form and shall have a chemical analysis as specified on plans, and shall

MINERALS AND ELEMENTAL SOIL AMENDMENTS Ferric sulfate shall be first-grade commercial quality, with a minimum of 20% metallic iron.

Soil Sulfur shall be approximately 99% sulfur. Phosphate fertilizers shall be supplied as single or triple superphosphate. Single superphosphate shall have an analysis range

from 0-18-0 to 0-22-0. Triple superphosphate shall have an analysis range from 0-39-0 to 0-46-0. In all cases, phosphate fertilizers shall be granular and free flowing.

Ammonium Phosphate shall be rated 11-48-0. Ammonium Sulfate shall be rated 20-0-0.

Gypsum shall be of standard agricultural grade.

Calcium carbonate lime shall be first quality commercial grade.

comply with the requirements of the agricultural code of the State of California.

Potassium nitrate shall be first quality commercial grade.

Fine sand shall be a standard horticultural product, clean and free from foreign matter or chemical contamination, suitable for incorporating into planting soil. Grading not to exceed that of "nursery sand" as supplied by Consolidated Rock Company. Sphagnum peat moss shall be a standard horticultural product. Its composition shall furnish ample water-holding capacity and retention of plant food, be free of sticks, stones, weedy roots, mineral or other foreign matter, and shall be delivered air dry in standard bales

B. Trees, Shrubs and Ground Cover:

Starter fertilizer with rooting hormone, 100% water soluble, apply at manufacturer's recommended rate.

Planting tablets: 21-gram size, 20-10-5 analysis. Apply at a rate of:

Trees 4 tablets per tree

Shrubs 2 tablets per shrub c. Ground cover 1 tablet each plant

Seeded and Sodded Areas: High quality balanced (N, P, K, pH) fertilizer designed for region and local soils, as recommended in soils report, including slow release nitrogen.

2.4 STAKES AND GUYS

A. Material as per standard detail.

2.5 MULCH

A. Ground fir or hemlock bark (no pine) of uniform color, free from weeds, seeds, sawdust, and splinters, and shall not contain resin, tannin, wood fiber, salts, or other compounds detrimental to plant life. Size range of 1/2 inch to 1-1/4 inches (12 to 32 mm) with maximum of 30 percent passing a 1/2-inch (12 mm) screen.

2.6 HYDROMULCH

A. Select wood fiber mulch and emulsifier as approved. 2.7 TACKIFIER

A. J-Tac or approved equal. Apply at manufacturer's suggested rate (minimum 40 lbs./acre) on all seeded slopes over 3:1.

2.8 HEADER BOARD

A. Permaloc CleanLine Aluminum edging, 3/16" x 4", Mill finish or equal

PART 3 EXECUTION

3.1 REVIEW

A. Verify installation conditions as satisfactory to receive work of this section. Do not install until unsatisfactory conditions are corrected. Beginning work constitutes acceptance of conditions as satisfactory.

Verify sub-grades and final grades in rough seeded areas as properly prepared.

Give appropriate notice of adverse drainage conditions.

Verify grades with Architect, Owner's Representative and General Contractor before commencement of planting, preferably at time of staking and layout.

E. Give appropriate notice of contaminants discarded by other trades, such as thinner, cementitious products, and the like.

3.2 FINISH GRADING A. Finish grade all planting, lawn and rough seeded areas and fine grade as may be necessary or incidental to all planting operations. Establish finish grades in accordance with elevations shown in the Drawings, insuring that no pockets nor any other surface obstructions to

positive drainage are present. Insure positive drainage away from building.

Sub-grades shall be established at the following depths below finish grade:

Planting Areas within 10 feet (3 m) of buildings: 8 inches (200 mm), consisting of 6 inches (150 mm) topsoil and 2 inches mulch Other Planting Areas: 6 inches (150 mm), consisting of 4 inches (100 mm) topsoil and 2 inches (50 mm) mulch.

Rough Grass: Finish grade all rough grass areas using on site material.

required in rough seeded areas.

Lawn Areas: 4 inches (100 mm). C. Acceptable Tolerance: One inch (25 mm) plus or minus throughout, 1/2-inch (12 mm) adjacent to paving or structures.

D. Prior to placing topsoil in areas, thoroughly rototil all planting and lawn areas to a depth of 6 inches (150 mm). Place topsoil uniformly over entire area, and rototil to a depth of 6 inches (150 mm), incorporating amendments and subsoil with topsoil. No tilling is

Rake, float, drag, roll, and perform all necessary operations to remove surface irregularities and to provide a firm, smooth surface with positive surface drainage. Remove all rocks, sticks, and other debris one inch (25 mm) and larger in planting lawn areas and rough seeded areas.

F. Grade as indicated after installation of topsoil and mulch flush with adjacent surfaces unless otherwise specified or detailed. 3.3 PERFORMANCE

A. Planting Time: Plant trees, shrubs and ground covers during periods which are normal for such work, as determined by season, weather conditions, and accepted practice. At the option and on the full responsibility of the Contractor, planting operations may be conducted under unseasonable conditions without additional compensation.

B. Plant Locations:

After placement of topsoil, stake tree locations and position shrubs above ground as per Drawings for approval. If ground position is more than 18 inches (460 mm) from plan position, consult with Landscape Architect or Owner's Representative before proceeding. Make minor field adjustments to avoid obstructions to planting such as irrigation equipment. Landscape Architect or Owner's Representative reserves the right to field adjust plant locations prior to planting.

2. All plants are required to have positively draining pits. Daylight planting pits, add draining swales or over excavate and backfill with gravel to provide well-drained conditions

B. Planting Trees:

Excavate tree pits twice the diameter of the root ball. Thoroughly scarify bottom of pits by shovel cutting to a depth of 12 inches (300 mm). Sides of pits shall also be shovel cut to help root penetration. If bedrock is encountered, mound soil around tree or relocate as

2. Place tree in upright position in center of pit, release root covering or spread roots. Roots of trees shall be so placed as to have a natural spread and distribution and planting mix shall be carefully, thoroughly packed and puddled around them. Take care not to injure root system while backfilling and compacting. After water settles, fill again with planting mix and water compact to a grade of not more than 1/2 inch (12 mm) higher than the original ball. Leave soil dished around the tree for watering purposes for trees, which are watered by bubblers

Extend tree pits as required to allow for proper drainage

4. Fertilize trees at the specified rate applied uniformly around circumference of root spread under a cover of 3 inches (76 mm) of planting mix. Stake and guy trees immediately after planting as per standard detail. All supports and trees shall stand vertical.

D. Planting Shrubs and Ground Cover:

After topsoil placement and approval of finish grade, excavate planting pockets at locations shown on Drawings and as directed to a diameter of twice the root spread and to a depth that will insure a 3-inch (75 mm) cushion of compacted planting mix below the root ball. 2. Set plants upright in center of hole flush with finish grade, release root covering or spread roots. The roots of the plant shall be placed as to have a natural spread and distribution. Backfill with specified planting mix to finish grade, working soil well around the roots and heel tamping to compact backfill and provide slight depression as watering saucer. Care shall be taken not to injure the root system while backfilling and compacting the planting mix.

3. Fertilize at the specified rate applied uniformly around the circumference of the root spread under a cover of 3 inches (76 mm) of planting mix. Plant ground cover plants at spacing indicated in straight, evenly spaced, triangulated rows. First row of ground cover at 12 inches (300 mm) from paving or curb unless otherwise noted.

E. Sodding:

Soil Preparation: As per "Finish Grading" section.

Lay fresh sod with tight, staggered joints in a running bond pattern. In sloped areas, lay sod up and down slope. Trim edges adjacent to walks, curbs, walls, etc., for neat, tight fit. Rolling: When initial watering has settled out, in 24 to 48 hours, the sod shall be rolled diagonally with a 300-pound (136 kg) roller to hasten the bond between sod and topsoil bed.

4. After rolling, water sod thoroughly to 8 to 10 inch (200 to 250 mm) depth. 5. Repair any depressions, which develop through guarantee period.

1. Seed using specified mix with hydromulch, emulsifier, fertilizer and Jtac or other approved stabilizer for all slopes over 3:1. Protect areas from erosion and damage during establishment period.

Overseed any bare areas quickly and repair any settlement to provide a full, even, vigorous stand of grass.

Prior to seeding, water area to a minimum depth of 6 inches (150 mm).

G. Mulching:

F. Seeding:

1. Immediately after completion of all planting, mulch all planted areas to a minimum compacted depth of 3 inches (76 mm). Remove all irregular bark pieces, rock, soil clumps, and foreign material. 2. Rock and Decomposed Granite shall be installed at the depths indicated on the plans. All areas of rock or Decomposed Granite shall be separated from shrub areas and lawn areas with Aluminum header per the details. If no details exist installewr shall use Permaloc CleanLine Aluminum edging, 3/16" x 4", Mill finish or equal.

H. Pruning and Repair:

Upon completion of the work under this contract, all trees shall be pruned as directed by the Landscape Architect and Owner's Representative and any injuries repaired.

Pruning shall be done in such a manner as not to change the natural habit or shape of the plant. Required plant sizes are the size after pruning. All cuts shall be made flush, leaving no stubs. On all cuts over 3/4 inch (19 mm) in diameter and bruises or scars on the bark, the injured cambium shall be traced back to living tissue and removed. Wounds shall be smoothed and shaped so as not to retain water, and the treated area shall be coated with approved tree wound compound.

3.4 MAINTENANCE/PLANT MATERIALS

A. Begin maintenance following installation of each tree/shrub, ground cover, or lawn area and continue as follows until final acceptance:

Include watering, weeding, cultivating, spraying, fertilizing, mowing, tightening, and repairing of stakes, removal of dead materials, erosion repair, reseeding, resodding, resetting plants to proper grades and upright position, and other required operations, as frequently as

As soon as conditions permit within normal planting season, remove dead or unsatisfactory plants from site, as determined by the Landscape Architect or Owner's Representative. Replace removed plants with new specimens (at landscape subcontractor's expense). Refer

Protect and maintain until acceptance of the project, or agreed (in writing) partial-acceptance.

Replace any vandalized plant materials until the work is accepted by Owner.

Identify replacements and take whatever necessary steps to prevent similar demise of plant materials.

3.5 CLEANING

to Guarantee under Part 1.

A. Daily Cleanup: Keep site areas clean, neat and orderly:

Exclude dirt and rubbish from paved and planted areas.

Wash hard surfaces clean.

B. Final Cleanup: Maintain areas in clean, neat and orderly manner:

Prior to final review, remove deleterious material and debris.

Wash and clean hard surfaces, including paving and wall faces soiled by work of this section.

substantial completion per Division 2 Section "Landscape and Irrigation Maintenance".

3.6 PLANT SCHEDULE AND DETAILS

A. See Drawings.

3.7 EXTENDED MAINTENANCE A. In addition to the maintenance required until final acceptance, provide landscape maintenance for a period of ninety (90) days after

B. The installer shall also provide the "Owner" with a fee to perform the maintenance required for a period of one year the 90 day Extended Maintenance Period per Division 2 Section "Landscape and Irrigation Maintenance".

END OF SECTION

LADBS STAMP CLIENT:

Rexford

Maintain barriers around seeded and sodded areas until established, then remove from site.

Prior to final review, remove deleterious materials and debris. Rake neatly around plants to an even fine grade. Remove weeds.

Remove flag labels from trees and shrubs.

Rake and clean planting areas neatly to an even fine grade, with no weeds present.

4. On acceptance of the work, remove surplus material, equipment and debris from the site.

SHEET NO. 06/21/24

L401

DATE REVISION 06.21.24 Bid Addendum 'C'.

JOB NO.

SUBMITTAL

CLIENT SUBMITTAL

CLIENT RE-SUBMITTAL

CM220364

DATE

10/18/23

02.21.24

RE RIAL TRI S Ň 0

11620 WILSHIRE I OS ANGELES, C 14400 GARD UMMINGS CURLEYANDASSOCIATES, INC

LANDSCAPE SPECIFICATIONS

SHEET 9 OF 10

DESIGN **BSBDESIGN.COM**

PART 1 GENERAL

1.1 RELATED DOCUMENTS

A.Drawings and general provisions of the Contract, including General and Supplementary Conditions and Division 1 Specification Sections, apply to this Section.

1.2 SUMMARY

A. The work described herein may be performed as part of the Extended Maintenance requirements of separate Landscape Planting Section, the Irrigation Section, or as part of work contracted separately subsequent to completion of the Extended Maintenance requirements of the construction contract.

B. Work includes all labor, tools, specialized equipment, materials, qualified supervision and transportation to perform complete grounds maintenance work including landscape, irrigation, and seasonal color and to maintain the landscape in a healthy and attractive condition as described herein. All work in this specification is required to be performed as a part of this contract whether described in an active tense or not.

C.Provide regular maintenance services as outlined in these Landscape Maintenance Specifications and submit attached Maintenance Task Matrix to the Designated Representative for record.

D.Examine the landscape and irrigation during each required visit, looking for problems or potential

E. Provide at your own risk and expense all labor, materials, tools, equipment, insurance, transportation, hauling, dumping, and all other items needed to provide the services outlined in this Specification.

F. Make minor replacements and repairs to the landscape and irrigation items as part of the required maintenance work. Report major items needing replacement or repair to the Designated Representative within one week of occurrence. A minor item is something that takes less than one hour to repair by skilled workmen, using replacement parts with a total value of less than US\$30. A major item requires more than one hour to repair and/or requires replacement parts with value in excess of US\$30. Be available to perform major items related to the landscape and irrigation maintenance as may be authorized in writing by the Designated Representative.

1.2 PRE QUALIFICATION

A.To be eligible to perform the work described herein, Landscape Contractor shall have a wide range of knowledge and minimum 5 years industry experience in landscape maintenance with a high standard of workmanship and performance.

B. Proof of relevant experience shall be provided in the form of a record of minimum of 5 recent landscape maintenance projects including:

1. Project name and description 2. Contract type and scope of work

3. Client contact information

4. Contract sum 5. Dates of work

C.Also provide names of state licensed Herbicide/Pesticide applicators employed by the Landscape Contractor who are anticipated to perform the work specified herein.

1.3 PROTECTION

A. Take all reasonable precautions required to protect plants from abnormal temperatures. Confine work to areas designated.

B. Take care to prevent damage to adjacent property

C.Store materials or equipment in a safe manner in conformance to with all applicable codes and requirements only in areas designated by the Warehouse Manager.

1.4 ACTION SUBMITTALS

A. Submit samples and information sheets to the Designated Representative for approval, for any proposed substitution(s) and for materials not specified by manufacturers, and as noted herein.

B. Required submittals include the following -

1. Fertilizer, 2. Herbicides

3. Seed Mixes, 4. Pesticides,

5. Pesticide Application Records,

6. Maintenance Schedule and Maintenance Task Matrix.

1.5 MAINTENANCE TASK MATRIX

A. The Maintenance Task Matrix shall be updated after each site visit.

B. Weeks in which visits do not occur or tasks that are not completed should be noted on the Matrix.

C. The Matrix should be available for review by Designated Representative at any time.

D.A completed Maintenance Task Matrix is to be submitted at the end of each quarter to the Designated Representative for his/her review and record.

E. The Landscape Contractor should retain a record copy of all completed Matrixes.

1.6 OWNER NOTIFICATION

A.Review site during each site visit to determine presence of any conditions hazardous to health, safety, or welfare. Notify the Designated Representative immediately of any such hazardous conditions.

1.7 REPAIR

A.Prune plant material to repair minor damage caused by vandalism, traffic, acts of nature, or other

B. To the satisfaction of the Designated Representative, repair any damage caused by contractor's work to irrigation system, walls, planting or lawns, curbs, utilities, lighting or paving, including any damage caused by the improper application of fertilizers, pesticides and herbicides (including burning, brownout, death).

C.Remove and dispose of damaged or broken plant material off-site and in a legal manner.

1.8 REPLACEMENT

A.Inventory each site during each visit and provide the Designated Representative with list of plants that require replacement. Photograph dead plant material and notify the Designated Representative.

1. Do not remove plant material prior to the Designated Representative's approval.

B. Replacement of plant materials lost through vandalism, vehicle damage, or acts of nature is the responsibility of the Owner.

C.Contractor is responsible for replacement of plant material damaged by Contractor's work, including any damage caused by the improper application of fertilizers, pesticides and herbicides, and physical damage.

D.Replace with sod or reseed any lawn areas damaged by improper fertilizer application.

1.9 TIMING OF WORK

A. All maintenance work provided under this contract shall be provided during hours when the warehouse

1. Confirm hours with the Warehouse Manager.

2. No work shall be performed during business hours unless specifically approved in advance in rare instances where evening or weekend hours cannot be used to accomplish the purpose.

1.10 VISIT FREQUENCY

A.Perform general maintenance at each site a minimum of once per week during the growing season.

1. Growing season is defined as the average frost-free season as substantiated by the National Climatic Data Center (90 percent probability of temperatures above 28 deg F (-2 deg C)).

B. Visits during the four weeks before and after the frost-free season shall occur at a minimum of once every two weeks. Visit frequency during the remainder of the year shall be a minimum of once

C.In severely cold climates, specific winter visits may be eliminated with prior approval of the Designated

D.Required minimum maintenance visits may be in addition to, or in conjunction with, other visits that are required to perform the tasks outlined in the following Specifications.

E. Provide the Designated Representative with a Maintenance Schedule indicating the average growing season for the Warehouse location, proposed days of visits, names of supervisor, and contact person.

F. Submit this schedule on a yearly basis at the beginning of the contract year and revise as needed.

1.11 INSPECTION OF WORK

A. The Designated Representative will regularly inspect all maintenance performed under this contract.

B. The Designated Representative may at any time request correction or improvement of maintenance practices if they fall below contract standards.

C.Contractor is expected to make necessary corrections within 72 hours of receipt of such request.

D. These requests may be made in writing, email, by telephone, facsimile or in person, and may be given

can be left for the contractor 24 hours a day. An answering machine connected to the contractor's

normal phone line is an acceptable method of meeting this requirement. Check for messages every 24

to you or your on-site representative. 1.12 CONTACT PERSON A.Provide the Designated Representative with a phone number and an email address where a message

hours or less. 1.13 EXISTING CONDITIONS / EXAMINATION OF SITE

A. Within two weeks of the starting date for work under this contract, make a thorough examination of the current conditions at the site.

1. As part of this examination, confirm that the existing plantings in each planter meet or exceed those shown on construction plans or any more current plant inventories.

2. Make a list of all landscape items at the site that you believe are broken, missing, not healthy, or are otherwise not in compliance with these specifications.

3. Give a copy of this list, along with an additional itemized quote for correcting each item, to the Designated Representative. 4. Upon confirmation of each item, the Designated Representative will either give you written

authorization to make the correction, or a written release from responsibility for the item.

B. By submitting a bid on this work, you are considered to have examined the landscape, irrigation and these specifications, and to have thoroughly familiarized yourself with the scope of the required work.

1.14 DEFINITIONS

A.Landscape Contractor or Contractor: The person, partnership, corporation, or agency that will perform the landscape maintenance work.

B.Designated Representative: The person, partnership, corporation, or agency that contracted for the performance of the landscape maintenance work.

1. The designated representative may be the Owner, , client, project manager, Landscape Architect, or the General Contractor. Referred to as "Owner Client"

C. The landscape contractor is responsible for obtaining confirmation of who the Designated Representative is for the contracted work.

D.Excluded damage:

1. Damage caused by vandalism, pedestrians, vehicles, animals, or other unusual factors. 2. This term does not include damage caused by the contractor's actions, lack of reasonable care, insects or rodents, diseases, or plant loss due to lack of water or over watering caused by an irrigation system programming error, irrigation system breakage, or irrigation malfunction, or lack of a timely repair to irrigation system.

1.15 SERVICE AGREEMENT

A. The intent of this maintenance specification is to integrate with any contractual agreement the Contractor has with "Owner or Client" for landscape maintenance.

B.In bidding the landscape and irrigation and maintenance work, contractor agrees to sign and abide by the terms of the contractual agreement with "Owner or Client" which may include requirements for indemnification and insurance.

C.Landscape Contractor's agreement shall be the prevailing agreement and no requirement of this specification shall be construed to override that agreement.

PART 2 MATERIALS AND PRODUCTS

2.1 FERTILIZER

A. Approved high quality balanced organic fertilizer (N, P, K, pH) designed for region and local soils conforming to applicable state fertilizer laws.

1. Uniform in composition, dry, free flowing, delivered to the site in original unopened containers, each bearing the manufacturer's guaranteed analysis. 2. Fertilizer composition shall be based upon the required yearly soil test.

B. Submit product literature for approval by the Designated Representative.

2.2 PESTICIDES

A.Pesticides approved by the Environmental Protection Agency and local jurisdiction. Submit product literature for approval by the Designated Representative.

1. Apply at rate recommended by manufacturer

2.3 HERBICIDES

A.Post- and pre-emergent herbicides approved by the Environmental Protection Agency and local

B. Submit product literature for approval by the Designated Representative. Apply at rate recommended by manufacturer.

2.4 BARK MULCH

A.Product matching existing mulch or if not available, medium - fine ground bark with a maximum twenty (20%) percent fines.

B. Other Mulches: Match existing mulches such as decomposed granite and gravel in color and size.

2.5 COMPOST

A. Approved organic compost as available from local sources.

PART 3 MAINTENANCE

3.1 GENERAL MAINTENANCE

A.Soil Testing: Test soil once per year beginning one-year post construction.

1. Test one sample from planting areas and one sample from lawn areas for N, P, and K trace

minerals, salinity, pH, and percent organic matter.

2. Samples should be soil combined from multiple sample sites.

3. Contact soil-testing lab for specific sampling guidelines. 4. Contractor shall request specific recommendations for amendments based on whether lawn or

planting area soil is being tested.

B. Provide copy of lab test results and recommendations to the Warehouse Manager for his/her record.

C.Leaf Collection: Collect fallen leaves from planting and paved areas, including all drives, and remove

them from site. Inspect each site and remove any leaf accumulation at each site visit.

D.Clean Up and Litter Removal:

1. Sweep or blow-off all walks and curbs at each site visit. Parking lots will be swept by others.

a. Do not use blowers prior to 6:00 A.M. or after 10:00 P.M. or at any other hours restricted by law. b. Do not use blowers around parked vehicles to avoid scratching vehicle paint with blowing sand c. Where use of blowers is prohibited by law, use alternate methods.

E.Remove all litter from sidewalks, gutters, and all planted areas at each site visit. In no case shall trash, litter, or leaves be blown or swept onto the property of others.

F. Collect all trash, litter, leaves, etc., haul away, and dispose off site in a legal manner.

G.Small amounts of grass clippings may be swept or blown back into lawn areas.

3.2 IRRIGATION

A. Water Application & Scheduling:

1. Hand water as needed to supplement natural rainfall and irrigation system, and to maintain plantings in a healthy, stress-free condition. Make sure plants receive adequate water regardless of weather

2. Conserve water and ensure that all watering rules and regulations are followed. Any penalties, fines, or citations for watering ordinance violations shall be paid by the contractor. 3. Utilize the permanent irrigation system, and supplement with hand watering as needed. Failure of the irrigation system to provide full and proper coverage does not relieve Contractor of the

responsibility to provide adequate irrigation. 4. Contractor is responsible for the complete operation and maintenance of the irrigation systems, except as noted below. Examine the irrigation system for damage during required visits and report damage or malfunction to the Designated Representative in writing. If contractor fails to report the broken or malfunctioning irrigation system components within one week of the breakage or malfunction, contractor will be responsible for all damages resulting from the broken irrigation

5. Adjust watering times each month and respond to weather changes. Do not over-water plantings. Use multiple-start times and short run times to prevent run-off. Do not allow run-off from any irrigation. 6. When breakdowns or malfunctions exist, hand water, if necessary, to maintain all plant material in a

healthy condition. If the irrigation repairs are major and not the fault of the contractor, they may be billed as additional work. Do not wait for approval to begin hand watering if required to save the plantings.

B.Irrigation System Scheduled Maintenance:

1. During each required site visit complete the following:

a. Check the entire irrigation system when the system is pressurized for items such as dry spots and missing or malfunctioning irrigation components. Check for leaking or damaged valves, water running across sidewalks, water standing in puddles, or any other condition which hampers the correct operation of the system or the public safety. Immediately repair deficiencies. b. Check for exposed piping paying particular attention to shallow drip tubing. Bury any exposed

piping to originally specified depths. c. Carefully observe plant materials for signs of wilting that may indicate an irrigation system problem. Plants which die due to irrigation failure will be considered to have died due to the contractor's negligence and shall be replaced at the contractor's expense d. Eliminate any puddling or excessive run-off of water from the irrigation system onto any paved areas. Immediately shut down the irrigation system and make adjustments, repairs, or

2. Maintain the irrigation system, including cleaning of filter screens yearly or more often as needed, and flushing pipes, as part of this contract.

replacements as soon as possible to correct the source of the run-off.

C.Irrigation System Repair:

will be paid for as additional work.

1. Replace or repair, at contractor's expense, minor irrigation damage, unless due to excluded damage. Make repairs within one week of the day the damage occurred. 2. If the damage was due to excluded damage or determined to be a major item, the irrigation repairs

a. Make notification of needed repairs within two (2) weeks of the day the damage occurred as noted in the General Requirements section of these specifications.

b. Regardless of the cause of damage, take immediate action to prevent further damage by shutting off the damaged part of the irrigation system and commencing with hand watering as needed. c. Make repairs as soon as possible after receiving written or verbal authorization to proceed.

END OF SECTION

LANDSCAPE MODIFICATIONS

PART 1 GENERAL

1.1 RELATED DOCUMENTS

A. Drawings and general provisions of the Contract, including General and Supplementary Conditions and Division 1 Specification Sections, apply to this Section.

1.2 SUMMARY

A. This Section includes removal of existing landscaping plant materials at areas shown on the drawings, then reinstall them at the new locations noted.

1.3 ACTION SUBMITTALS

A. Submit product certificates.

B. Submit Planting Schedule indicating anticipated dates and locations for each type of planting.

1.4 QUALITY ASSURANCE

A. Where reusing the existing landscape plants is not economically viable, provide new trees, shrubs, ground covers, and plants of quality, size, genus, species, and variety indicated, complying with applicable requirements of ANSI Z60.1 "American Standard for Nursery Stock."

1.5 SPECIAL WARRANTY

A. Warrant new trees and shrubs for a period of one year after date of Substantial Completion, against defects including death and unsatisfactory growth, except for defects resulting from lack of adequate maintenance, neglect, or abuse by Owner, abnormal weather conditions unusual for warranty period, or incidents which are beyond Contractor's control.

B. For purposes of bidding this project, base the bid on the assumption that all existing plant materials shown or scheduled to be relocated (removed, stored, then replanted), will remain viable in the new locations and will not require replacement.

C. Where relocated existing plants need replacement due to death or unsatisfactory growth, remove and replace with new trees and shrubs of the same species and similar size. This will be considered additional work, beyond the scope of the original bid and contract, except where replacement is due to lack of adequate maintenance, neglect, or abuse by the Contractor while the plantings were in the Contractor's control.

1.6 MAINTAIN TREES AND SHRUBS

A. As required to establish healthy, viable plantings for 12 months following Substantial Completion.

1.7 MAINTAIN GROUND COVER AND PLANTS

A. As required to establish healthy, viable plantings for 3 months following Substantial Completion.

PART 2 PRODUCTS

2.1 NEW TREES AND SHRUBS

A. Where relocated plants remain unhealthy or become dead, remove and replace with well-shaped, fully branched, healthy, vigorous nursery-grown stock of sizes and grades indicated, free of disease, insects, eggs, larvae, and defects, conforming to ANSI Z60.1.

2.2 NEW GROUND COVERS AND PLANTS

A. Established and well rooted in removable containers or integral peat pots and with not less than the minimum number and length of runners required by ANSI Z60.1 for the pot size indicated.

2.3 TOPSOIL

A. Amend existing soil with compost.

2.4 LIME

A. ASTM C 602, Class T, agricultural limestone.

2.5 COMPOST

A. minus, fully composted vegetative material.

2.6 MULCH

2.7 BONEMEAL

A. Ground bark free of weeds, seed or other contaminants. Size range: 1/2 to 1-1/4 inches (12 to 32 inches).

A. Commercial, raw, finely ground; minimum of four (4%) percent nitrogen and twenty (20%) percent phosphoric acid.

2.8 SUPERPHOSPHATE

A. Commercial, phosphate mixture, soluble; minimum of twenty (20%) percent available phosphoric acid.

derived from natural organic sources of urea-form, phosphorous, and potassium in the following composition:

A. Commercial-grade complete fertilizer of neutral character, consisting of fast- and slow-release nitrogen, fifty (50%) percent

2.9 COMMERCIAL FERTILIZER

2.10 WEED-CONTROL BARRIER

1-1/2 times as wide as ball diameter. Loosen hard subsoil in bottom of excavation.

rate. Water thoroughly after planting, taking care not to cover plant crowns with wet soil.

A. Polypropylene or polyester non-woven fabric, 3 oz. per sq. yd. (100 g per sq. m) minimum.

PART 3 EXECUTION

3.1 PLANT BED PREPARATION

A. Loosen sub-grade of planting bed areas to a minimum depth of 6 inches (150 mm). Remove stones larger than 1-1/2 inches (38 mm) in any dimension and sticks, roots, rubbish, and other extraneous materials. Mix in 2-inch (50 mm) depth of compost into top 6 inches (150 mm) of soil.

A. Excavate pits with vertical sides and with bottom of excavation slightly raised at center to assist drainage. Excavate approximately

3.2 EXCAVATION FOR TREES AND SHRUBS

3.3 PLANTING TREES AND SHRUBS A. Set stock plumb and in center of pit or trench with top of ball raised above adjacent finish grades. Fertilize at manufacturer's

3.4 TREE AND SHRUB PRUNING

recommended rate.

spread. Do not cut tree leaders; remove only injured or dead branches from flowering trees. Prune shrubs to retain natural character. Shrub sizes indicated are size after pruning. 3.5 PLANTING GROUND COVER

A. Space 24 inches (600 mm) apart, unless otherwise indicated. Dig holes large enough to allow spreading of roots. Work soil

around roots to eliminate air pockets and leave a slight saucer indentation around plants to hold water. Fertilize at manufacturer's

A. Prune, thin, and shape trees and shrubs according to standard horticultural practice. Prune trees to retain required height and

END OF SECTION

CLIENT SUBMITTAL 10/18/23 CLIENT RE-SUBMITTAL 02.21.24 DATE **REVISION** 06.21.24 Bid Addendum 'C'.

JOB NO.

SUBMITTAL

LADBS STAMP

CM220364

DATE



Ш 4 RIAL T N

S S 0 O WILSHIRE ANGELES, C 4400 ARD



DESIGN

LANDSCAPE SPECIFICATIONS

L402

06.21.24 SIGNATURE DATE

06/21/24

BSBDESIGN.COM

SHEET NO.

SHEET 10 OF 10